



45 STEEPLECHASE AVENUE TOWN OF AURORA

			Schedu	ule 1: Des	igner Informatio
A. Project		iews and takes res	sponsibility for design activit	ies with respect	to the project.
Building number	-tt	ECHASE AVENUE		Unit no.	Lot/con.
Municipality AU		Postal code	Plan number/ other descrip	tion	7-7-10
		1 - 100 0000 0000	20.375124600000000000000000000000	X12233	
Name		kes responsibil	lity for design activities	65 8 K 8 K 8	
DEAN H	RUFFOLO		DERO BUILDING D		TLot/con.
Street address	20 WERTHEIM COURT		COMMUNICATION OF THE PARTY.	Unit no. 13	
Municipality RIC	CHMOND HILL	Postal code L4B 3A8	Province ONTARIO	E-mail info@	derodesigns.com
Telephone numb 905) 889-8434		. Fax number		Cell number	
			entified in Section B. [Building Code T	able 3.5.2.1 of Division C
✓ Hous	e	☐ HVAC	– House	☐ Build	ling Structural
	Buildings Buildings		ng Services tion, Lighting and Power		ibing – House ibing – All Buildings
	olex Buildings	☐ Fire P			ite Sewage Systems
D. Declarat	ion of Designer DEAN R (print r	tUFFOLO		_declare that (ch	noose one as appropriate
I	DEAN R (print r	name) bility for the design	n work on behalf of a firm re he firm is registered, in the	egistered under s	subsection 3.2.4.of Divisio
I	DEAN R (print r	name) bility for the design	he firm is registered, in the	egistered under s	subsection 3.2.4.of Divisio
I	DEAN R (print n review and take responsi C, of the Building Code. I a	name) bility for the design am qualified, and t	he firm is registered, in the	egistered under s	subsection 3.2.4.of Divisio
I	DEAN R (print r review and take responsi C, of the Building Code. I a Individual BCIN: Firm BCIN: review and take responsi Inder subsection 3.2.5. of I	bility for the design am qualified, and t 23640 28051 bility for the design	he firm is registered, in the	egistered under s appropriate clas	subsection 3.2.4.of Divisionses/categories.
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I	DEAN R (print r review and take responsi c, of the Building Code. I a Individual BCIN: Firm BCIN: review and take responsi Inder subsection 3.2.5. of I Individual BCIN: Basis for exemption fr	bility for the design am qualified, and to 23640 28051	he firm is registered, in the	egistered under sappropriate class	subsection 3.2.4.of Divisionses/categories. ory as an "other designer"
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STATISTIC SCHEDULE

FIRST FLOOR AREA	3805 SQ. FT. (353.50 m2)
SECOND FLOOR AREA	1875 SQ. FT. (174.19 m2)
TOTAL AREA	5680 SQ. FT. (527.69 m2)
FIN. BASEMENT AREA	2770 SQ. FT. (257.34 m2)
GARAGE AREA	1885 SQ. FT. (175.12 m2)
COVERAGE INFORMATI	ON
MAIN HOUSE	3850 SQ. FT. (357.68 m2)
FRONT CONC. PORCH	115 SQ. FT. (10.68 m2)
REAR CONC. PORCH (RIGHT)	320 SQ. FT. (29.73 m2)
REAR CONC. PORCH (LEFT)	320 SQ. FT. (29.73 m2)
TOTAL COVERAGE	4605 SQ. FT. (427.82 m2) (4.93%)
ROOF HEIGHT	32'-8" (9.96 m)
Duffellle	

NOTES:

any discrepancies to the designer before commencing construction. Do not scale drawings.

The contractor must check and verify all dimensions and report

Joists to be at 12" O.C. where supporting ceramic tile.

BCIN INFORMATION:

takes responsibility for this design, and has the qualifications and meets the requirements set out in the Ontario Building Code to be a designe

QUALIFICATION INFORMATION Required unless design is exempt under subsections 3.2.4. and 3.2.5. of Division C of the Ontario Building Code.

Required unless design is exempt under subsections 3.2.4. and 3.2.5. of Division C of the Ontario Building Code.

STRUCTURAL STATE



PROPOSED TWO STOREY 45 STEEPLECHASE AVE. AURORA, ON.


DEVELOPMENTS



T 905 889 8434 F 905 889 8435

info@derodesigns.com www.derodesigns.com

CHECKED BY DWG. NO. APR 15, 2024

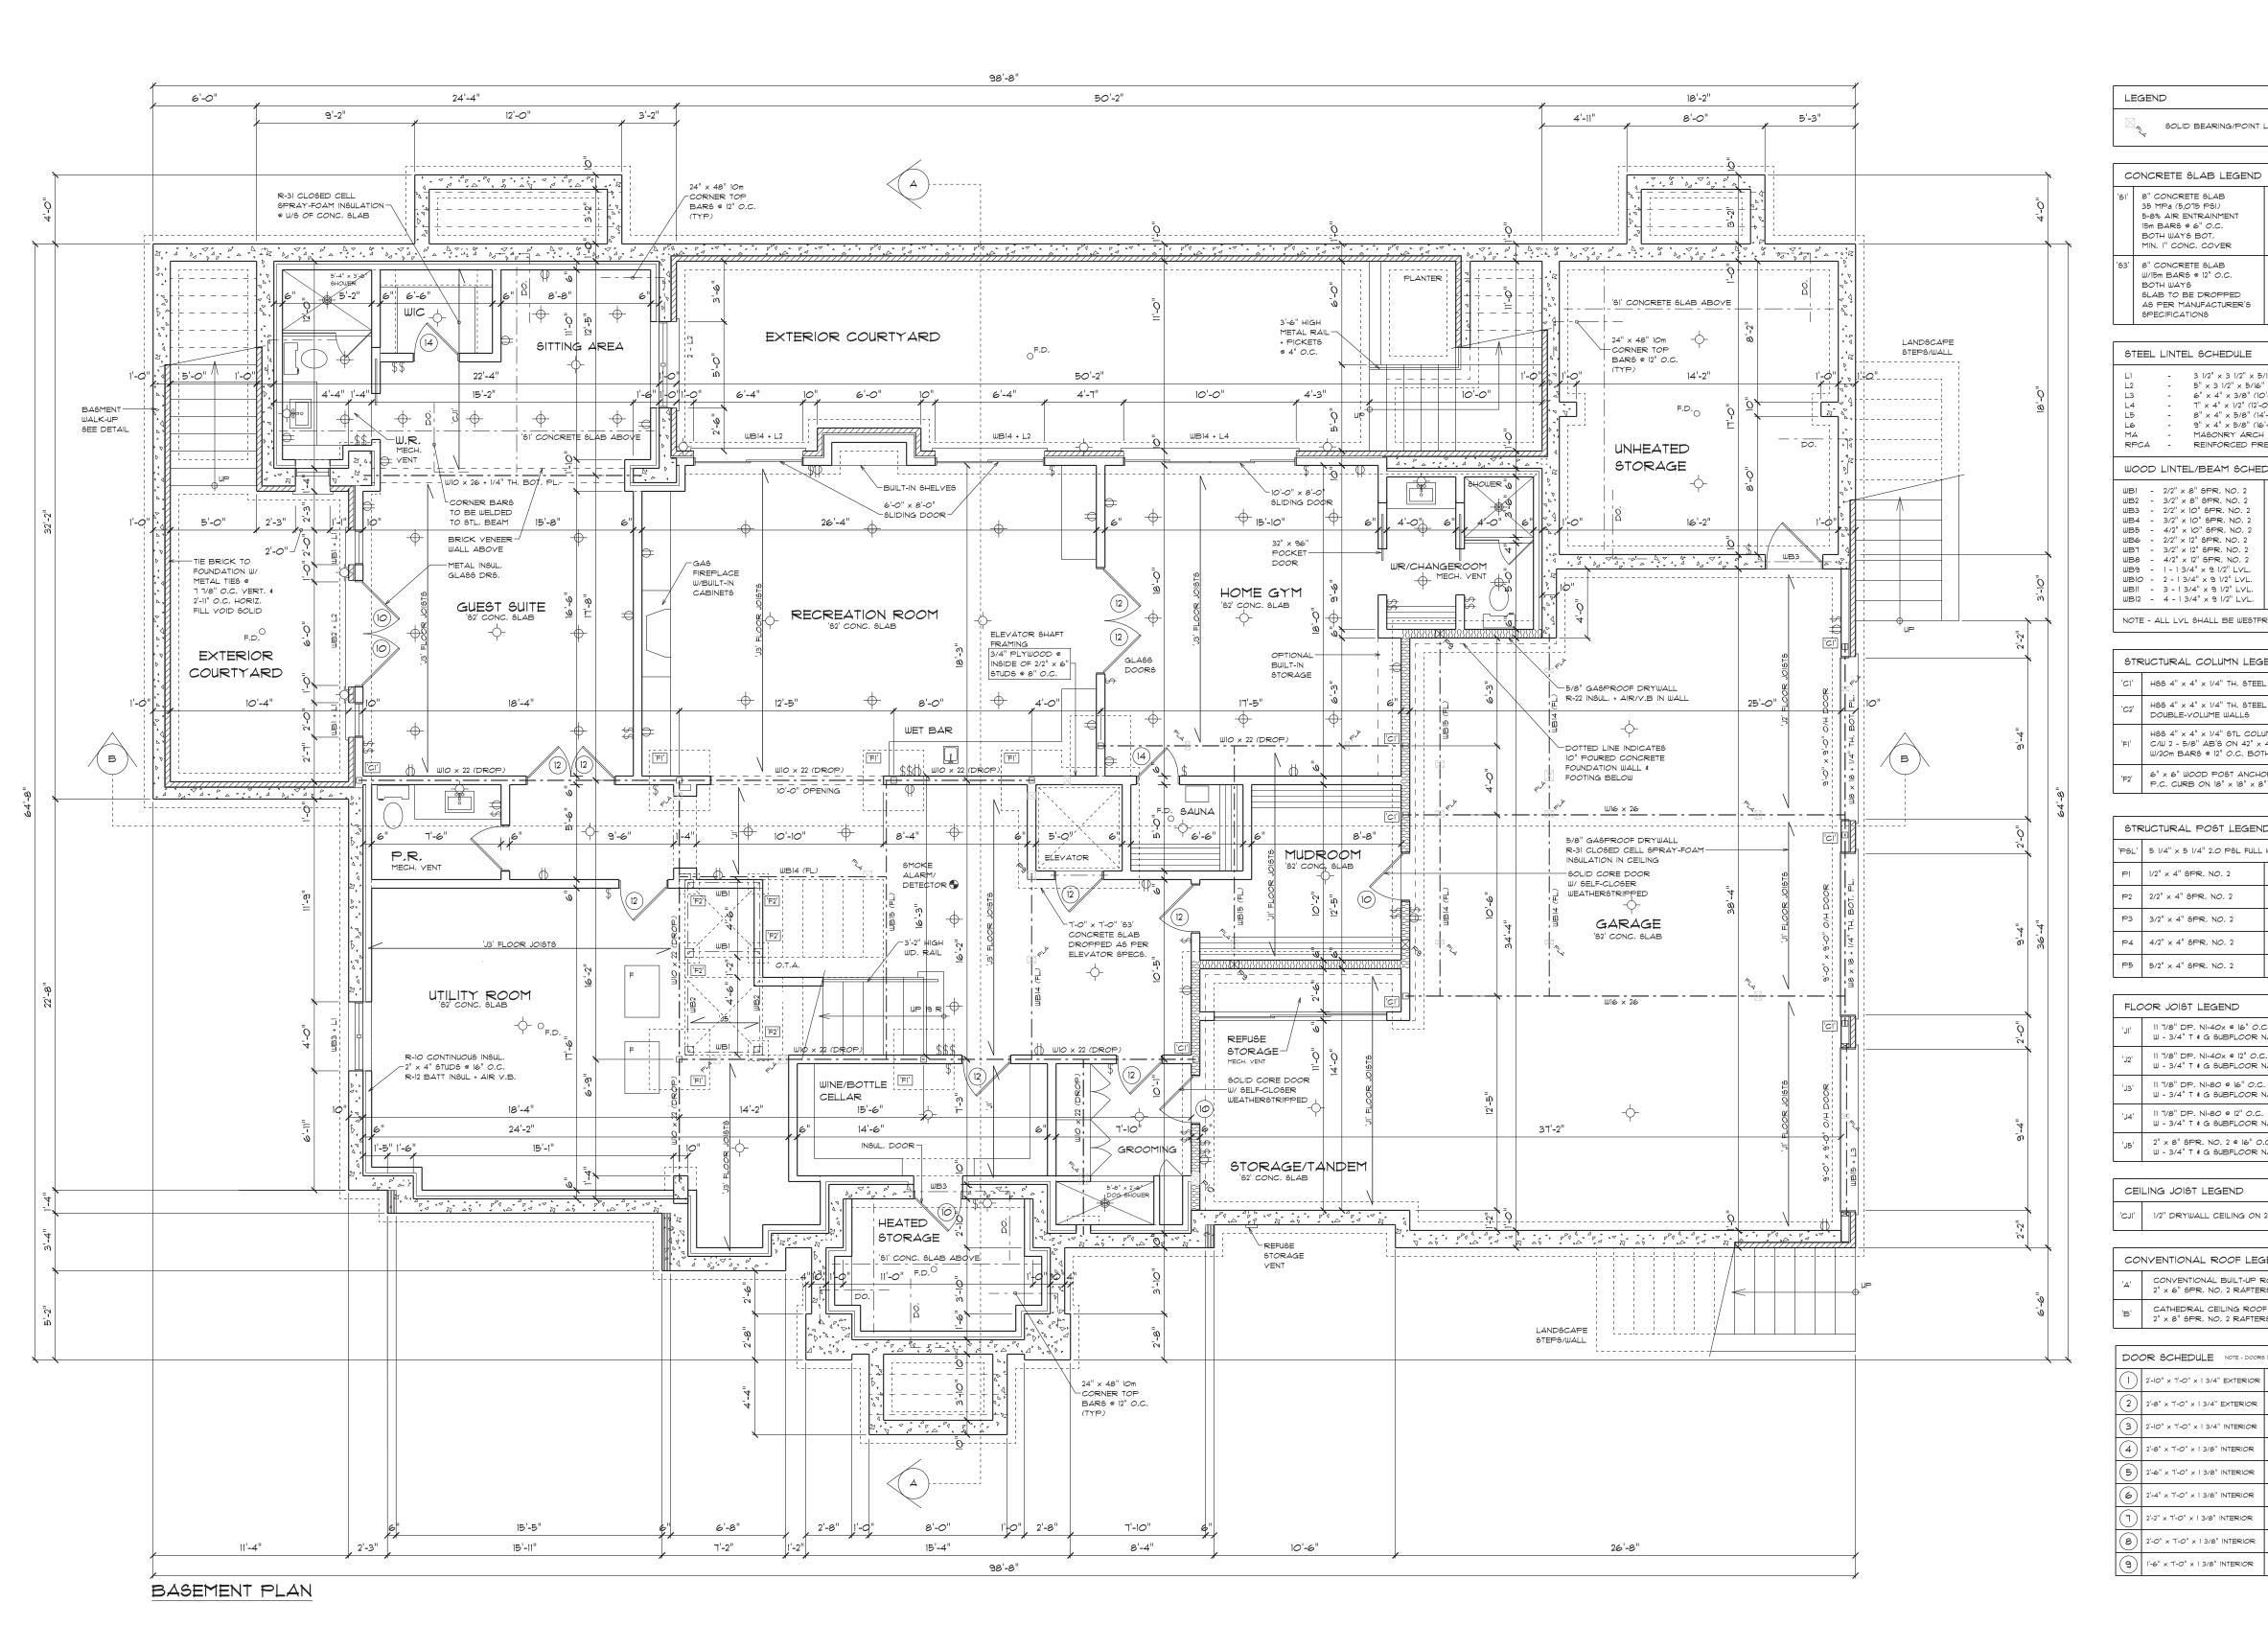

SOLID BEARING/POINT LOAD ABOVE

8" CONCRETE SLAB 35 MPa (5,075 PSI) 5-8% AIR ENTRAINMENT 32 MPa (4650 PSI) 5-8% AIR ENTRAINMENT 15m BARS @ 6" O.C. 4" GRAYEL BOTH WAYS BOT. MIN, 1" CONC, COYER 8" CONCRETE SLAB '54' 5" CONCRETE SLAB W/15m BARS @ 12" O.C. BOTH WAYS 32 MPa (4650 PSI) 5-8% AIR ENTRAINMENT SLAB TO BE DROPPED 6" x 6" WIRE MESH ON AS PER MANUFACTURER'S 6" COMPACTED GRAVEL

STEEL LINTEL SCHEDULE

3 1/2" x 3 1/2" x 5/16" (6'-0" MAX, \$PAN) (4" BRG.)
5" x 3 1/2" x 5/16" (8'-0" MAX, \$PAN) (6" BRG.)
6" x 4" x 3/8" (10'-0" MAX, \$PAN) (6" BRG.)
7" x 4" x 1/2" (12'-0" MAX, \$PAN) (8" BRG.)
8" x 4" x 5/8" (14'-0" MAX, \$PAN) (10" BRG.) $9" \times 4" \times 5/8"$ (16'-0" MAX, SPAN) (12" BRG.) MASONRY ARCH REINFORCED PRECAST CONC. ARCH

WOOD LINTEL/BEAM SCHEDULE

WBI	-	2/2" x 8" SPR. NO. 2	WB13 - 1-13/4" x 117/8" L
WB2	-	3/2" x 8" SPR, NO, 2	WB14 - 2-13/4"×117/8"L
WB3	-	2/2" × 10" SPR, NO, 2	WB15 - 3-13/4" x 117/8" L
WB4	-	3/2" x 10" SPR, NO, 2	WB16 - 4 - 1 3/4" x 11 7/8" L
WB5	-	4/2" x 10" SPR, NO, 2	WBIT - 1-13/4" x 14" LVL.
WB6	-	2/2" × 12" SPR. NO. 2	WB18 - 2 - 1 3/4" x 14" LVL.
WBT	-	3/2" x 12" SPR, NO, 2	WB19 - 3 - 1 3/4" × 14" LVL
WB8	-	4/2" x 12" SPR, NO, 2	WB20 - 4 - 1 3/4" x 14" LVL
WB9	-	1 - 1 3/4" × 9 1/2" LVL.	WB21 - 1-13/4" x 16" LVL.
WB10	-	2 - 1 3/4" × 9 1/2" LVL.	WB22 - 2-13/4" x 16" LVL.
WBII	-	3 - 1 3/4" × 9 1/2" LVL.	WB23 - 3 - 1 3/4" × 16" LVL
WB12	-	4 - 1 3/4" × 9 1/2" LVL.	WB24 - 4 - 1 3/4" × 16" LVL

NOTE - ALL LYL SHALL BE WESTFRASER (2,0E 3100) LYL OR EQUIV.

STF	RUCTURAL COLUMN LEGEND
'C1'	HSS 4" × 4" × 1/4" TH, STEEL PIPE COLUMN
'C2'	H\$6 4" x 4" x 1/4" TH, \$TEEL PIPE COLUMN FOR DOUBLE-VOLUME WALL\$
' F 1'	H\$6 4" \times 4" \times 1/4" \$TL COLUMN W/IO" \times IO" \times 3/4" BOT, PL. C/W 2 - 5/8" AB'\$ ON 42" \times 42" \times 18" PAD FOOTING REINF, W/20m BAR\$ @ 12" O.C. BOTH WAY\$
'F2'	6" x 6" WOOD POST ANCHORED TO 6" x 6" x 6" DP, P.C. CURB ON 18" x 18" x 8" DP, P.C. PAD FOOTING

STRUCTURAL POST LEGEND

'PSL'	5 1/4" × 5 1/4" 2.0 PSL FULL	HEIGH1	COLUMN AT "TALL WALLS
PI	1/2" × 4" 6PR, NO, 2	P6	1/2" × 6" SPR. NO. 2
P2	2/2" × 4" SPR, NO, 2	PT	2/2" × 6" SPR, NO, 2
P3	3/2" × 4" SPR, NO, 2	P8	3/2" x 6" SPR. NO. 2
P4	4/2" × 4" SPR, NO, 2	P9	4/2" x 6" SPR, NO, 2
P5	5/2" × 4" SPR, NO, 2	PIO	5/2" × 6" SPR. NO. 2

FLC	OOR JOIST LEGEND
'ונ'	1/8" DP. NI-40x @ 6" O.C. W - 3/4" T & G \$UBFLOOR NAILED & GLUED
'J2'	1/8" DP. NI-40x @ 2" O.C. W - 3/4" T & G \$UBFLOOR NAILED & GLUED
'J3'	11 7/8" DP. NI-80 @ 16" O.C. W - 3/4" T & G SUBFLOOR NAILED & GLUED
'J4'	11 7/8" DP. NI-80 ⊕ 12" O.C. W - 3/4" T & G \$UBFLOOR NAILED & GLUED
'J5'	2" x 8" SPR, NO. 2 @ 16" O.C. W - 3/4" T & G SUBFLOOR NAILED & GLUED

CEILING JOIST LEGEND

1/2" DRYWALL CEILING ON 2" \times 8" 5PR, NO, 2 @ 16" O.C.

CONVENTIONAL ROOF LEGEND

CONVENTIONAL BUILT-UP ROOF OF $2" \times 6"$ SPR, No. 2 RAFTERS + CEILING JOISTS @ 16" O.C. CATHEDRAL CEILING ROOF FRAMING OF

DOOR SCHEDULE NOTE - DOORS MAY BE GLAZED, REFER TO WORKING DRAWINGS.				
<u>-</u>	2'-10" × T'-0" × 1 3/4" EXTERIOR	(<u>©</u>	2'-10" x 8'-0" x 1 3/4" EXTERIO	
2	2'-8" × 7'-0" × 1 3/4" EXTERIOR	(\equiv)	2'-8" × 8'-0" × 1 3/4" EXTERIOR	
3	2'-10" × T'-0" × 1 3/4" INTERIOR	12	2'-10" x 8'-0" x 1 3/4" INTERIOR	
4	2'-8" × 7'-0" × 1 3/8" INTERIOR	(<u>3</u>)	2'-8" × 8'-0" × 1 3/8" INTERIOR	
(F)	2'-6" × 7'-0" × 1 3/8" INTERIOR	(14)	2'-6" × 8'-0" × 1 3/8" INTERIOR	
(0)	2'-4" × 7'-0" × 1 3/8" INTERIOR	(Ū	2'-4" × 8'-0" × 1 3/8" INTERIOR	
(-	2'-2" × 7'-0" × 1 3/8" INTERIOR	(1)	2'-2" x 8'-0" x 1 3/8" INTERIOR	
$\overline{\mathbb{S}}$	2'-0" x T'-0" x 1 3/8" INTERIOR	(<u>1</u>	2'-0" x 8'-0" x 1 3/8" INTERIOR	
a	1'-6" x 7'-0" x 1 3/8" INTERIOR	(8)	1'-6" x 8'-0" x 1 3/8" INTERIOR	
	·		·	

and has the qualifications and meets

The undersigned has reviewed and takes responsibility for this design,

Do not scale drawings.

The contractor must check and verify all dimensions and report any discrepancies to the designer before commencing construction.

Joists to be at 12" O.C. where supporting ceramic tile.

BCIN INFORMATION:

NOTES:

the requirements set out in the Ontario Building Code to be a designer QUALIFICATION INFORMATION

Required unless design is exempt under subsections 3.2.4. and 3.2.5. of Division C of the Ontario Building Code.

REGISTRATION INFORMATION

Required unless design is exempt under subsections 3.2.4. and 3.2.5. of Division C of the Ontario Building Code.

by an original signature.

This Certification is NOT valid unless accompanied

STRUCTURAL STAMP



PROPOSED TWO STOREY 45 STEEPLECHASE AVE.

AURORA, ON. FOR

> ANIX DEVELOPMENTS

BASEMENT PLAN




Richmond Hill, Ontario L4B 3A8

T 905 889 8434 F 905 889 8435

info@derodesigns.com www.derodesigns.com

DATE	SCALE
APR 15, 2024	3/16" = 1'-0"
DRAWN BY	CHECKED BY
D.R.	D.R.
PROJ. NO.	DWG. NO.

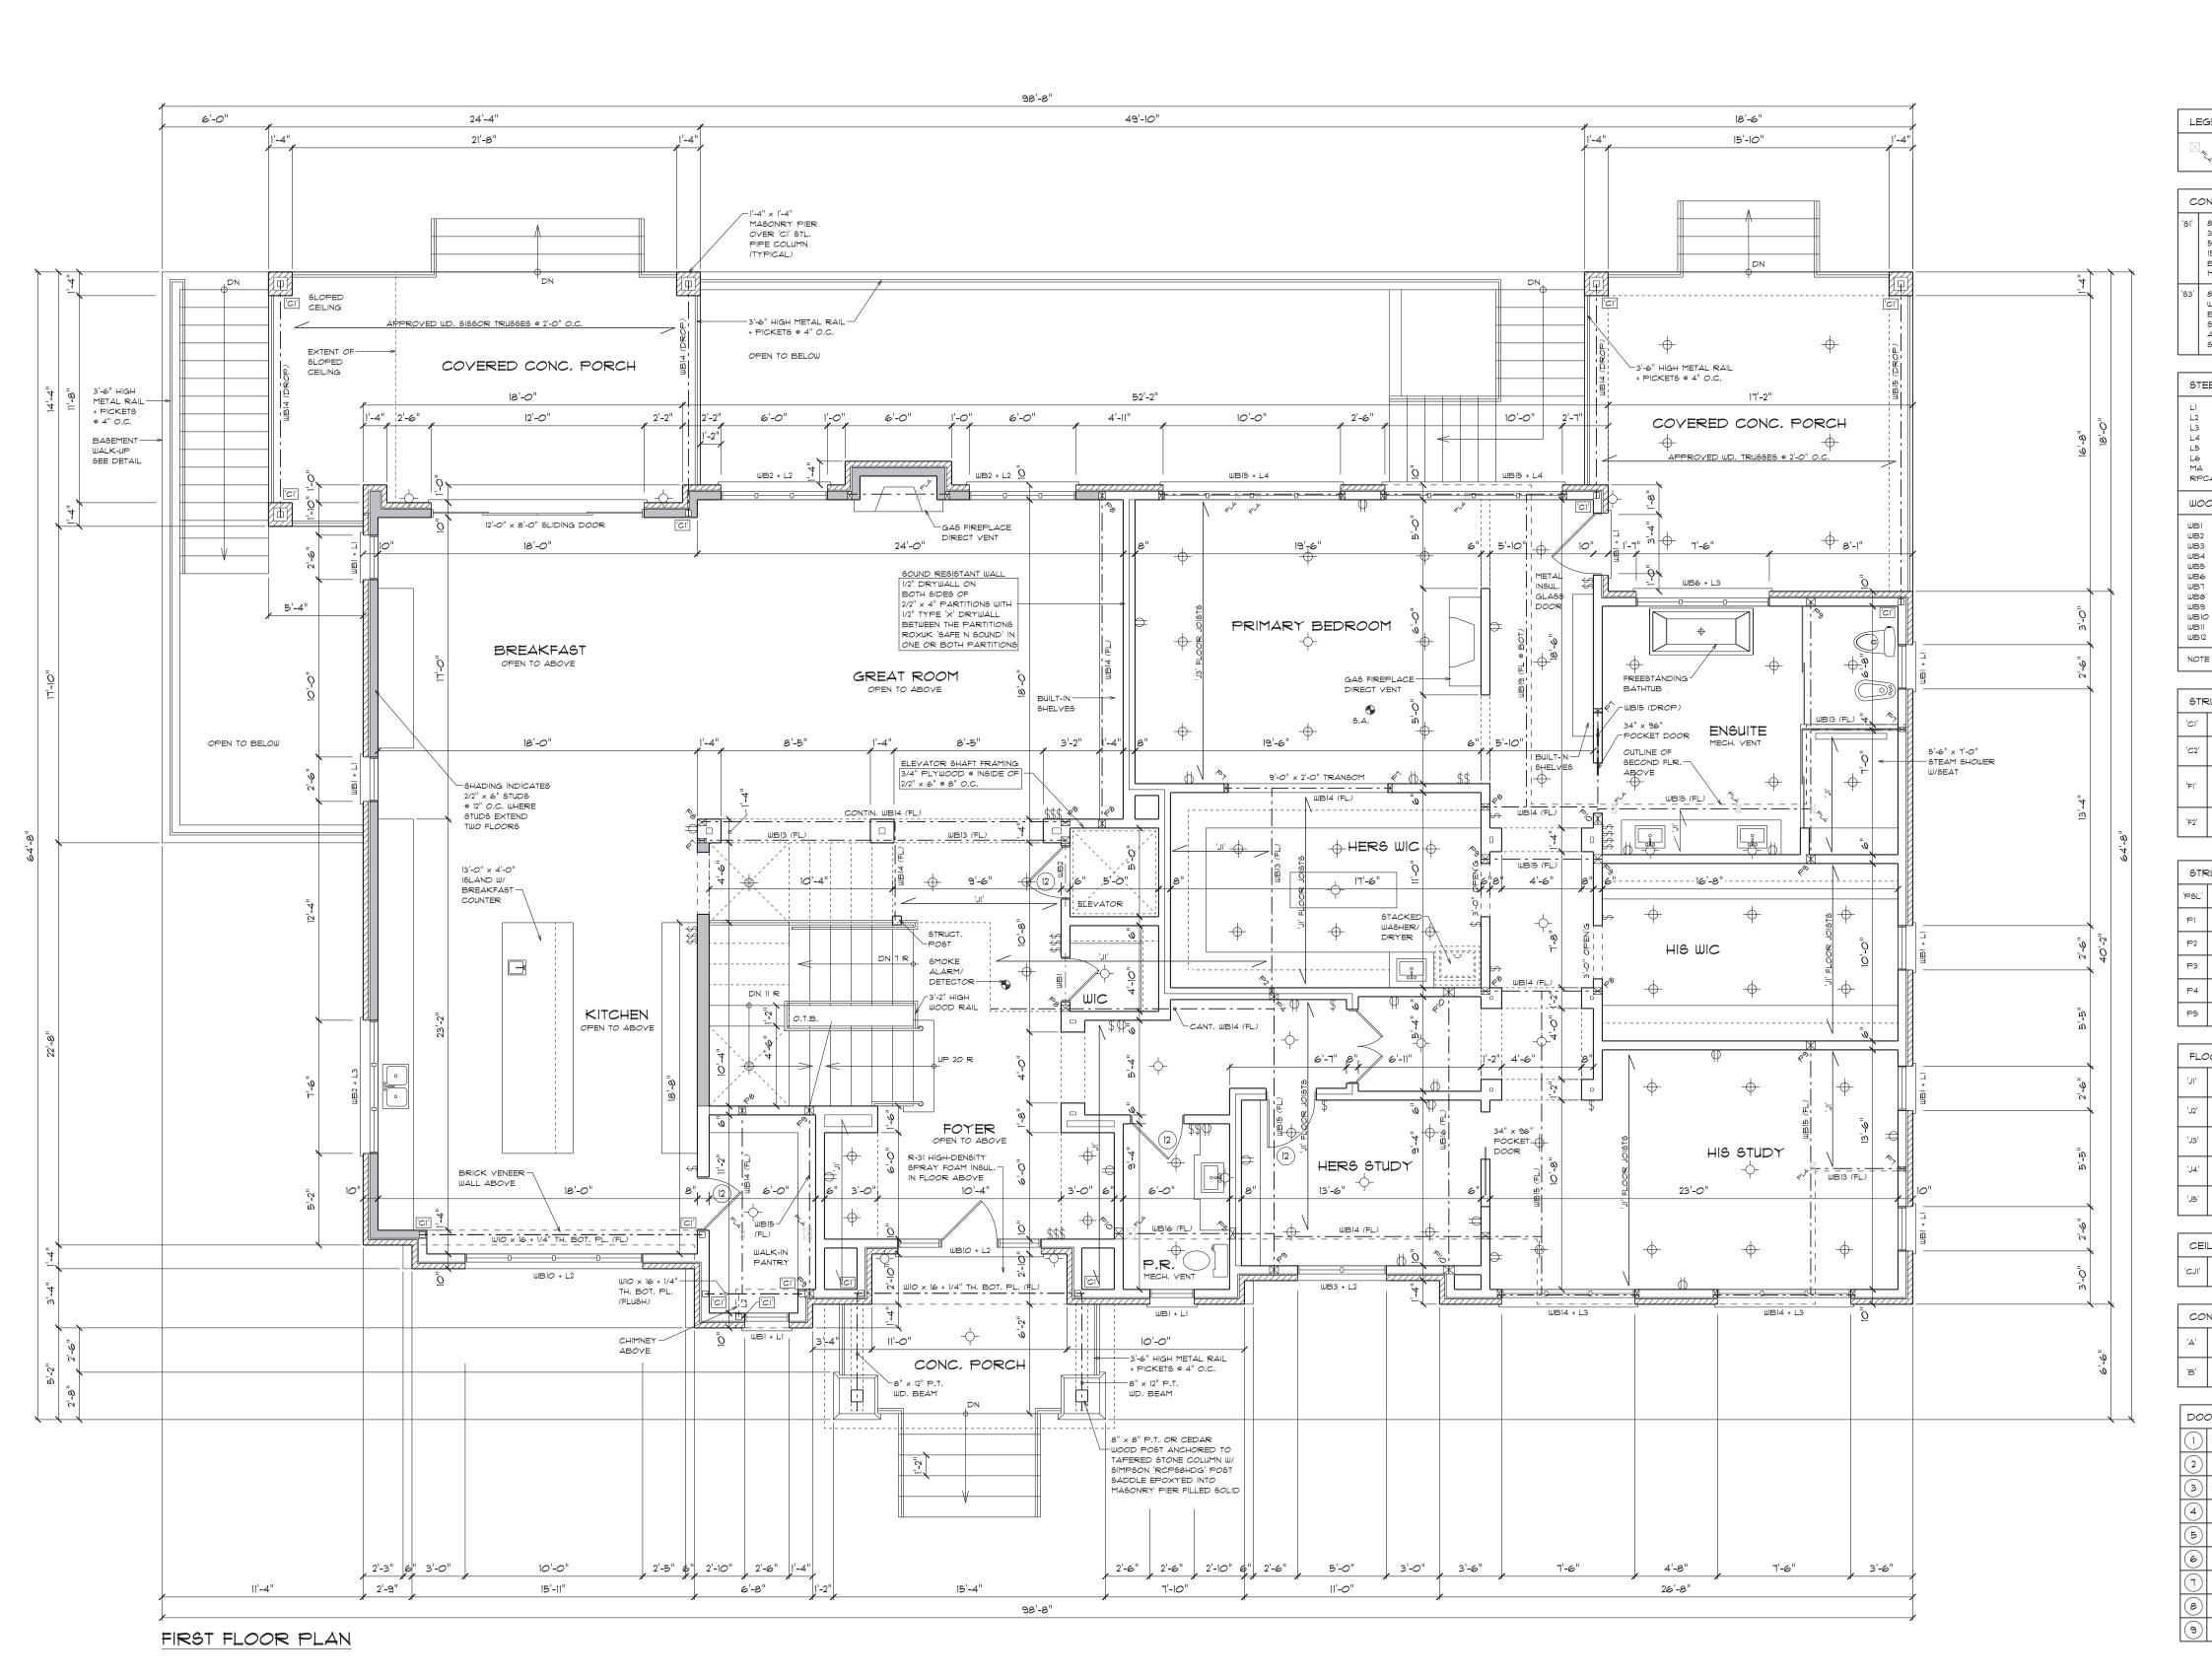

LEGEND

SOLID BEARING/POINT LOAD ABOYE

CONCRETE SLAB LEGEND '52' 3" CONCRETE SLAB 'SI' 8" CONCRETE SLAB 32 MPa (4650 PSI) 5-8% AIR ENTRAINMENT 35 MPa (5,075 PSI) 5-8% AIR ENTRAINMENT 15m BARS @ 6" O.C. BOTH WAYS BOT. 4" GRAVEL MIN, I" CONC, COVER '93' 8" CONCRETE SLAB 54' 5" CONCRETE SLAB 32 MPa (4650 PSI) 5-8% AIR ENTRAINMENT W/15m BARS @ 12" O.C. BOTH WAYS SLAB TO BE DROPPED AS PER MANUFACTURER'S 6" x 6" WIRE MESH ON 6" COMPACTED GRAVEL SPECIFICATIONS

STE	ΞL	LINTEL SCHEDULE		
L1				MAX. SPAN) (4" BRG.)
L2				X, SPAN) (6" BRG.)
L3				SPAN) (6" BRG.)
L4 L5		- 7" × 4" × 1/2" (12'-0		PAN)(8" BRG.) SPAN)(IO" BRG.)
L5 L6				SPAN) (12" BRG.)
MA		- 9 X 4 X 5/8 (16 - MASONRY ARCH		SPAN) (12 BRG.)
RPC	٨	- REINFORCED PR		NC ARCH
121 0	-	- KEINI OKOED I K	10401 00	NO. AROH
WOC	D	LINTEL/BEAM SCHEI	DULE	
WB1	-	2/2" × 8" SPR. NO. 2	WB13 -	1 - 1 3/4" × 11 7/8" LVL.
WB2	-	3/2" × 8" SPR, NO, 2	WB14 -	2 - 1 3/4" × 11 7/8" LVL.
WB3	-	2/2" x 10" SPR. NO. 2	WB15 -	3 - 1 3/4" × 11 7/8" LVL
WB4	-	3/2" × 10" SPR, NO, 2	WB16 -	4 - 1 3/4" × 11 7/8" LVL
WB5	-	4/2" x 10" SPR, NO, 2		1 - 1 3/4" × 14" LVL.
WB6		2/2" × 12" SPR. NO. 2		2 - 1 3/4" × 14" LVL.
WBT	-	3/2" × 12" SPR, NO, 2		3 - 1 3/4" x 14" LVL.
WB8	-	4/2" x 12" SPR, NO, 2		4 - 1 3/4" x 14" LVL.
WB9	-	1 13/1 / 0 //2 = 11=/		1 - 1 3/4" × 16" LVL.
WB10		2 - 1 3/4" × 9 1/2" LVL.		2 - 1 3/4" × 16" LYL.
WBII		3 - 1 3/4" x 9 1/2" LVL,		3 - 1 3/4" x 16" LVL.
WB12	-	4 - 1 3/4" × 9 1/2" LVL.	WB24 -	4 - 1 3/4" × 16" LVL.

NOTE - ALL LYL SHALL BE WESTFRASER (2.0E 3100) LYL OR EQUIY.

STF	RUCTURAL COLUMN LEGEND
'C1'	HSS 4" x 4" x 1/4" TH. STEEL PIPE COLUMN
'C2'	H66 4" x 4" x 1/4" TH, 6TEEL PIPE COLUMN FOR DOUBLE-YOLUME WALLS
' = 1'	H66 4" \times 4" \times 1/4" 6TL COLUMN W/10" \times 10" \times 3/4" BOT, PL. C/W 2 - 5/8" AB'6 ON 42" \times 42" \times 18" PAD FOOTING REINF, W/20m BAR6 \otimes 12" O.C. BOTH WAY6
'F2'	6" x 6" WOOD POST ANCHORED TO 6" x 6" x 6" DP. P.C. CURB ON 18" x 18" x 8" DP. P.C. PAD FOOTING

STRUCTURAL POST LEGEND				
'PSL'	5 1/4" x 5 1/4" 2.0 PSL FULL	HEIGHT	COLUMN AT "TALL WALLS"	
₽Ί	1/2" × 4" 6PR. NO. 2	P6	1/2" × 6" SPR, NO, 2	
P2	2/2" × 4" SPR, NO, 2	₽Ţ	2/2" × 6" SPR, NO, 2	
P 3	3/2" × 4" SPR. NO. 2	P8	3/2" × 6" SPR. NO. 2	
₽4	4/2" × 4" SPR, NO, 2	P9	4/2" × 6" SPR. NO. 2	
P5	5/2" x 4" SPR. NO. 2	P10	5/2" x 6" SPR. NO. 2	

FLC	FLOOR JOIST LEGEND				
'J1'	11 7/8" DP. NI-40x @ 16" O.C. W - 3/4" T & G SUBFLOOR NAILED & GLUED				
'J2'	1/8" DP. NI-40x @ 2" O.C. - 3/4" T & G SUBFLOOR NAILED & GLUED				
'J3'	1/8" DP. N -80 ⊕ 6" O.C. W - 3/4" T & G SUBFLOOR NAILED & GLUED				
'J4'	1/8" DP. NI-80 ⊕ 2" O.C. W - 3/4" T & G SUBFLOOR NAILED & GLUED				
'J5'	2" x 8" SPR. NO. 2 @ 16" O.C. W - 3/4" T & G SUBFLOOR NAILED & GLUED				

CEILING JOIST LEGEND 'CJI' 1/2" DRYWALL CEILING ON 2" x 8" 6PR, NO. 2 @ 16" O.C.

CO	CONVENTIONAL ROOF LEGEND				
'A'	CONVENTIONAL BUILT-UP ROOF OF 2" x 6" 9PR, NO. 2 RAFTERS + CEILING JOISTS @ 16" O.C.				
'B'	CATHEDRAL CEILING ROOF FRAMING OF 2" × 8" SPR. NO. 2 RAFTERS © 16" O.C.				

DO	OR SCHEDULE NOTE - DOORS	MAY BE	GLAZED, REFER TO WORKING DRAWINGS.
	2'-10" × T'-0" × 1 3/4" EXTERIOR	(<u>Q</u>	2'-10" × 8'-0" × 1 3/4" EXTERIO
2	2'-8" × 7'-0" × 1 3/4" EXTERIOR	\equiv	2'-8" × 8'-0" × 1 3/4" EXTERIO
3	2'-10" x 1'-0" x 1 3/4" INTERIOR	(2)	2'-10" × 8'-0" × 1 3/4" INTERIOR
4	2'-8" x T'-0" x 1 3/8" INTERIOR	(<u>m</u>)	2'-8" × 8'-0" × 1 3/8" INTERIOR
5	2'-6" x 1'-0" x 1 3/8" INTERIOR	(14)	2'-6" x 8'-0" x 1 3/8" INTERIOR
6	2'-4" x T'-0" x 1 3/8" INTERIOR	(<u>#</u>	2'-4" × 8'-0" × 1 3/8" INTERIOR
7	2'-2" × 1'-0" × 1 3/8" INTERIOR	(1)	2'-2" × 8'-0" × 1 3/8" INTERIOR
8	2'-0" x 1'-0" x 1 3/8" INTERIOR	(<u>I</u>	2'-0" x 8'-0" x 1 3/8" INTERIOR
e	1'-6" x 7'-0" x 1 3/8" INTERIOR	(8)	1'-6" × 8'-0" × 1 3/8" INTERIOR

NOTES:

The contractor must check and verify all dimensions and report any discrepancies to the designer before commencing construction. Do not scale drawings.

supporting ceramic tile. **BCIN INFORMATION:**

Joists to be at 12" O.C. where

The undersigned has reviewed and takes responsibility for this design,

the requirements set out in the Ontario Building Code to be a designer QUALIFICATION INFORMATION Required unless design is exempt under subsections 3.2.4. and 3.2.5. of Division C of the Ontario Building Code.

and has the qualifications and meets

REGISTRATION INFORMATION Required unless design is exempt under subsections 3.2.4. and 3.2.5. of Division C of the Ontario Building Code.

This Certification is NOT valid unless accompanie by an original signature.

STRUCTURAL STAMP



PROPOSED TWO STOREY 45 STEEPLECHASE AVE. AURORA, ON.

FOR

ANIX DEVELOPMENTS

FIRST FLOOR PLAN




20 Wertheim Crt. U13 Richmond Hill, Ontario L4B 3A8

> T 905 889 8434 F 905 889 8435

info@derodesigns.com www.derodesigns.com

APR 15, 2024 3/16" = 1'-0" DRAWN BY CHECKED BY PROJ. NO. DWG. NO.

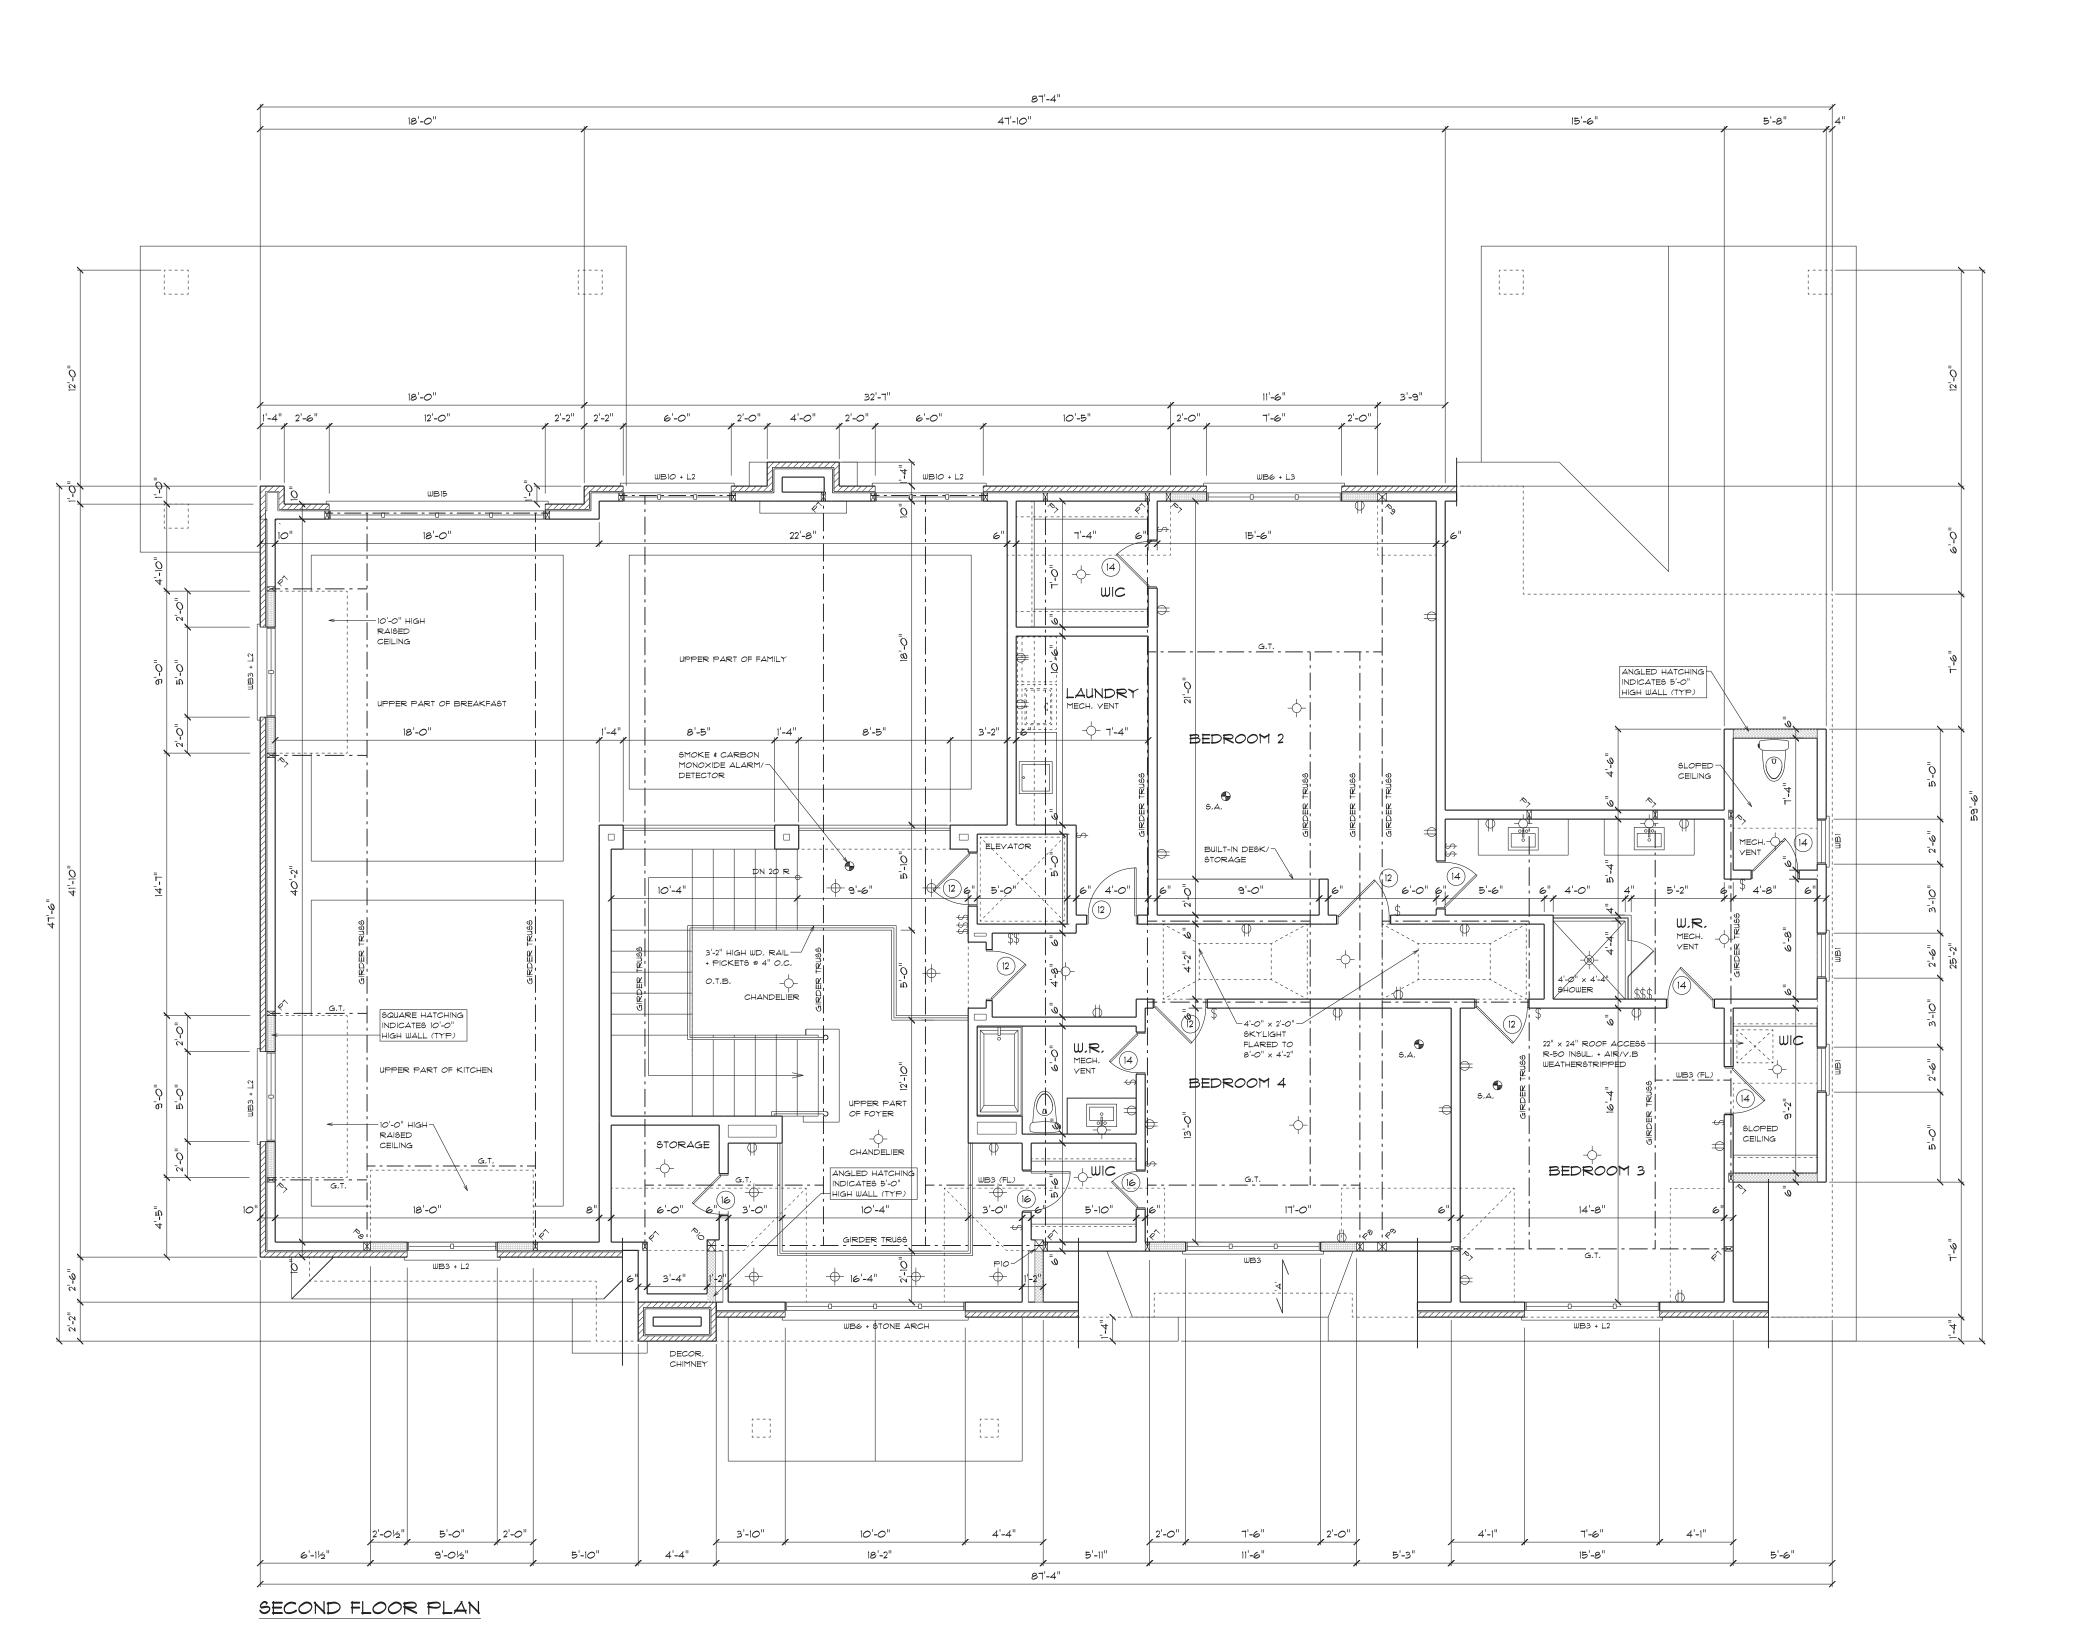

'A'	CONVENTIONAL BUILT-UP F 2" x 6" SPR, NO, 2 RAFTER		
'B'	CATHEDRAL CEILING ROOF 2" x 8" SPR, NO, 2 RAFTER		
DOG	OR SCHEDULE NOTE - DOORE	MAY BE	GLAZED, REFER TO WORKING DRAWINGS.
	2'-10" × T'-0" × 1 3/4" EXTERIOR	10	2'-10" × 8'-0" × 1 3/4" EXTERIOR
2	2'-8" × 7'-0" × 1 3/4" EXTERIOR	(1)	2'-8" × 8'-0" × 1 3/4" EXTERIOR
3	2'-10" × 1'-0" × 1 3/4" INTERIOR	(12)	2'-10" x 8'-0" x 1 3/4" INTERIOR
4	2'-8" x 7'-0" x 1 3/8" INTERIOR	(13)	2'-8" × 8'-0" × 1 3/8" INTERIOR
5	2'-6" x 1'-0" x 1 3/8" INTERIOR	(14)	2'-6" × 8'-0" × 1 3/8" INTERIOR
6	2'-4" × 7'-0" × 1 3/8" INTERIOR	(15)	2'-4" x 8'-0" x 1 3/8" INTERIOR
7	2'-2" × 1'-0" × 1 3/8" INTERIOR	(16)	2'-2" × 8'-0" × 1 3/8" INTERIOR
8	2'-0" x 1'-0" x 1 3/8" INTERIOR	[7]	2'-0" x 8'-0" x 1 3/8" INTERIOR
	1' 6" × 1' 0" × 1 3/8" INTERIOR	(10)	1' 6" v 8' 0" v 1 3/8" INTERIOR

LEGEND

SOLID BEARING/POINT LOAD ABOVE

32 MPa (4650 PSI)

32 MPa (4650 PSI)

5-8% AIR ENTRAINMENT

6" x 6" WIRE MESH ON 6" COMPACTED GRAVEL

4" GRAVEL

 $3\ 1/2" \times 3\ 1/2" \times 5/16" (6'-0" MAX, SPAN) (4" BRG.)$

5" x 3 1/2" x 5/16" (8'-0" MAX, SPAN) (6" BRG,) 6" x 4" x 3/8" (10'-0" MAX, SPAN) (6" BRG,)

T" × 4" × 1/2" (12'-0" MAX, 6PAN) (8" BRG.) 8" × 4" × 5/8" (14'-0" MAX, 6PAN) (10" BRG.) $9" \times 4" \times 5/8"$ (16'-0" MAX, SPAN) (12" BRG.) MASONRY ARCH

REINFORCED PRECAST CONC. ARCH

NOTE - ALL LYL SHALL BE WESTFRASER (2.0E 3100) LYL OR EQUIV.

5-8% AIR ENTRAINMENT

CONCRETE SLAB LEGEND

'SI' 8" CONCRETE SLAB

35 MPa (5,075 PSI) 5-8% AIR ENTRAINMENT

15m BARS @ 6" O.C. BOTH WAYS BOT.

BOTH WAYS

SPECIFICATIONS

MIN, 1" CONC, COYER '63' 8" CONCRETE SLAB W/15m BARS @ 12" O.C.

SLAB TO BE DROPPED
AS PER MANUFACTURER'S

STEEL LINTEL SCHEDULE

WOOD LINTEL/BEAM SCHEDULE

STRUCTURAL COLUMN LEGEND

STRUCTURAL POST LEGEND

1/2" \times 4" SPR, NO, 2

2/2" × 4" SPR, NO, 2

P3 | 3/2" × 4" 5PR, NO, 2

P4 4/2" x 4" SPR, NO, 2

P5 5/2" x 4" SPR, NO, 2

FLOOR JOIST LEGEND

CEILING JOIST LEGEND

11 7/8" DP, NI-40x @ 16" O.C. W - 3/4" T & G SUBFLOOR NAILED & GLUED

W - 3/4" T & G SUBFLOOR NAILED & GLUED

W - 3/4" T & G SUBFLOOR NAILED & GLUED

'CJI' 1/2" DRYWALL CEILING ON 2" x 8" SPR, NO, 2 @ 16" O.C.

2" x 8" SPR, NO, 2 @ 16" O.C. W - 3/4" T & G SUBFLOOR NAILED & GLUED

11 7/8" DP. NI-80 @ 16" O.C. W - 3/4" T & G SUBFLOOR NAILED & GLUED

11 7/8" DP, NI-40x @ 12" O.C.

11 7/8" DP, NI-80 @ 12" O.C.

CONVENTIONAL ROOF LEGEND

H66 4" x 4" x 1/4" TH, STEEL PIPE COLUMN

HSS 4" x 4" x 1/4" TH, STEEL PIPE COLUMN FOR DOUBLE-YOLUME WALLS

H&\$ 4" × 4" × 1/4" \$TL COLUMN W/10" × 10" × 3/4" BOT, PL. C/W 2 - 5/8" AB'\$ ON 42" × 42" × 18" PAD FOOTING REINF, W/20m BAR\$ @ 12" O.C. BOTH WAY\$

P6 | 1/2" x 6" SPR. NO. 2 2/2" x 6" SPR, NO, 2

3/2" x 6" SPR, NO, 2

4/2" x 6" SPR, NO, 2

5/2" x 6" SPR, NO, 2

6" \times 6" WOOD POST ANCHORED TO 6" \times 6" \times 6" DP. P.C. CURB ON 18" \times 18" \times 8" DP. P.C. PAD FOOTING

DO	DOOR SCHEDULE NOTE - DOORS MAY BE GLAZED, REFER TO WORKING DRAWINGS.				
$(\overline{-})$	2'-10" × T'-0" × 1 3/4" EXTERIOR	10	2'-10" × 8'-0" × 1 3/4" EXTERIOR		
(2)	2'-8" × 7'-0" × 1 3/4" EXTERIOR	(1)	2'-8" × 8'-0" × 1 3/4" EXTERIOR		
(M)	2'-10" × 1'-0" × 1 3/4" INTERIOR	(12)	2'-10" x 8'-0" x 1 3/4" INTERIOR		
4	2'-8" × 7'-0" × 1 3/8" INTERIOR	13	2'-8" × 8'-0" × 1 3/8" INTERIOR		
$\left(\mathfrak{h}\right)$	2'-6" × 1'-0" × 1 3/8" INTERIOR	14	2'-6" × 8'-0" × 1 3/8" INTERIOR		
(0)	2'-4" × 7'-0" × 1 3/8" INTERIOR	15	2'-4" x 8'-0" x 1 3/8" INTERIOR		
(r)	2'-2" × 1'-0" × 1 3/8" INTERIOR	16	2'-2" × 8'-0" × 1 3/8" INTERIOR		
(3)	2'-0" x 1'-0" x 1 3/8" INTERIOR	[17]	2'-0" x 8'-0" x 1 3/8" INTERIOR		
(9)	1'-6" x 7'-0" x 1 3/8" INTERIOR	(18)	1'-6" x 8'-0" x 1 3/8" INTERIOR		

Õ	OR SCHEDULE NOTE - DOORS	MAY BE	GLAZED, REFER TO WORKING DRAWINGS.
$(\overline{-})$	2'-10" × T'-0" × 1 3/4" EXTERIOR	10	2'-10" x 8'-0" x 1 3/4" EXTERIO
2	2'-8" x 7'-0" x 1 3/4" EXTERIOR	(1)	2'-8" × 8'-0" × 1 3/4" EXTERIO
3	2'-10" × 1'-0" × 1 3/4" INTERIOR	(12)	2'-10" × 8'-0" × 1 3/4" INTERIO
4	2'-8" x 1'-0" x 1 3/8" INTERIOR	(13)	2'-8" × 8'-0" × 1 3/8" INTERIOR
Б	2'-6" x 1'-0" x 1 3/8" INTERIOR	(14)	2'-6" x 8'-0" x 1 3/8" INTERIOR
6	2'-4" × T'-0" × 1 3/8" INTERIOR	(15)	2'-4" × 8'-0" × 1 3/8" INTERIOR
7	2'-2" × 7'-0" × 1 3/8" INTERIOR	(16)	2'-2" × 8'-0" × 1 3/8" INTERIOR
8	2'-0" x 1'-0" x 1 3/8" INTERIOR	(17)	2'-0" x 8'-0" x 1 3/8" INTERIOR
(9)	1'-6" x 7'-0" x 1 3/8" INTERIOR	(18)	1'-6" x 8'-0" x 1 3/8" INTERIOR

	2'-10" x 7'-0" x 1 3/4" EXTERIOR	10	2'-10" x 8'-0" x 1 3/4" EXTERIOR
2	2'-8" x 7'-0" x 1 3/4" EXTERIOR	(1)	2'-8" × 8'-0" × 1 3/4" EXTERIOR
3	2'-10" x 1'-0" x 1 3/4" INTERIOR	(12)	2'-10" x 8'-0" x 1 3/4" INTERIOR
4	2'-8" x 1'-0" x 1 3/8" INTERIOR	13	2'-8" x 8'-0" x 1 3/8" INTERIOR
5	2'-6" x 1'-0" x 1 3/8" INTERIOR	(14)	2'-6" x 8'-0" x 3/8" INTERIOR
6	2'-4" x 1'-0" x 1 3/8" INTERIOR	15	2'-4" x 8'-0" x 1 3/8" INTERIOR
7	2'-2" × 7'-0" × 1 3/8" INTERIOR	(16)	2'-2" × 8'-0" × 1 3/8" INTERIOR
8	2'-0" x 1'-0" x 1 3/8" INTERIOR	[17]	2'-0" × 8'-0" × 1 3/8" INTERIOR
(e)	1'-6" x T'-0" x 1 3/8" INTERIOR	(18)	1'-6" x 8'-0" x 1 3/8" INTERIOR

SECOND FLOOR	, <i>O.C.</i>	R5 @ 16	O. 2 RAFIER
PLAN	GLAZED, REFER TO WORKING DRAWINGS,	RS MAY BE	NOTE - DOORS
	2'-10" x 8'-0" x 1 3/4" EXTERIOR	10	4" EXTERIOR
	2'-8" × 8'-0" × 1 3/4" EXTERIOR	11	4" EXTERIOR
	2'-10" × 8'-0" × 1 3/4" INTERIOR	12	/4" INTERIOR
	2'-8" × 8'-0" × 1 3/8" INTERIOR	13	3" INTERIOR
	2'-6" x 8'-0" x 1 3/8" INTERIOR	14	6" INTERIOR
7DEDO	2'-4" x 8'-0" x 1 3/8" INTERIOR	(15)	3" INTERIOR
DERO	2'-2" x 8'-0" x 1 3/8" INTERIOR	(16)	" INTERIOR

NOTES:

The contractor must check and verify all dimensions and report any discrepancies to the designer before commencing construction.

Joists to be at 12" O.C. where supporting ceramic tile.

BCIN INFORMATION:

The undersigned has reviewed and takes responsibility for this design, and has the qualifications and meets the requirements set out in the Ontario Building Code to be a designer QUALIFICATION INFORMATION Required unless design is exempt under subsections 3.2.4. and 3.2.5. of Division C of the Ontario Building Code.

REGISTRATION INFORMATION Required unless design is exempt under subsections 3.2.4. and 3.2.5. of Division C of the Ontario Building Code.

This Certification is NOT valid unless accompanie

by an original signature.

STRUCTURAL STAMP

ANIX
DEVELOPMENTS

PROPOSED

TWO STOREY

AURORA, ON.

FOR

ANIX

45 STEEPLECHASE AVE.

DEVELOPMENTS

Do not scale drawings.

DERO BUILDING DESIGNS 20 Wertheim Crt. U13 Richmond Hill, Ontario

L4B 3A8

T 905 889 8434 F 905 889 8435

info@derodesigns.com

www.deroc	www.aeroaesigns.com		
DATE	SCALE		
APR 15, 2024	3/16" = 1'-0"		
DRAWN BY	CHECKED BY		
D.R.	D.R.		
PROJ. NO.	DWG. NO.		



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supporting ceramic tile.

Ontario Building Code to be a designe
QUALIFICATION INFORMATION
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of the Ontario Building Code.

the requirements set out in the

REGISTRATION INFORMATION
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Dero Building Designs Consultants Inc. 2809
FIRM NAME BC

FIRM NAME BCIN

This Certification is NOT valid unless accompanied by an original signature.

NO. REVISION DATE





PROPOSED
TWO STOREY
45 STEEPLECHASE AVE.
AURORA, ON.

FOR

ANIX DEVELOPMENTS

FRONT &
REAR
ELEVATIONS



L4B 3A8 T 905 889 8434

F 905 889 8435

info@derodesigns.com www.derodesigns.com

DATE	SCALE
APR 15, 2024	3/16" = 1'-0"
DRAWN BY	CHECKED BY
D.R.	D.R.
PROJ. NO.	DWG. NO.



NOTES:

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Joists to be at 12" O.C. where

BCIN INFORMATION:

supporting ceramic tile.

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Ontario Building Code to be a designe

QUALIFICATION INFORMATION

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Dean Ruffolo

NAME

BC

and has the qualifications and meets the requirements set out in the

REGISTRATION INFORMATION
Required unless design is exempt under
subsections 3.2.4. and 3.2.5. of Division C
of the Ontario Building Code.

Dero Building Designs Consultants Inc. 28051

BCIN DEFINE NAME BCIN

FIRM NAME BCIN

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NO. REVISION DATE

STRUCTURAL STAMP





TWO STOREY

45 STEEPLECHASE AVE.
AURORA, ON.

FOR

ANIX DEVELOPMENTS

LEFT-SIDE & RIGHT-SIDE ELEVATIONS




20 Wertheim Crt. U13 Richmond Hill, Ontario L4B 3A8

T 905 889 8434 F 905 889 8435

info@derodesigns.com www.derodesigns.com

DATE	SCALE
APR 15, 2024	3/16" = 1'-0"
DRAWN BY	CHECKED BY
D.R.	D.R.
PROJ. NO.	DWG. NO.

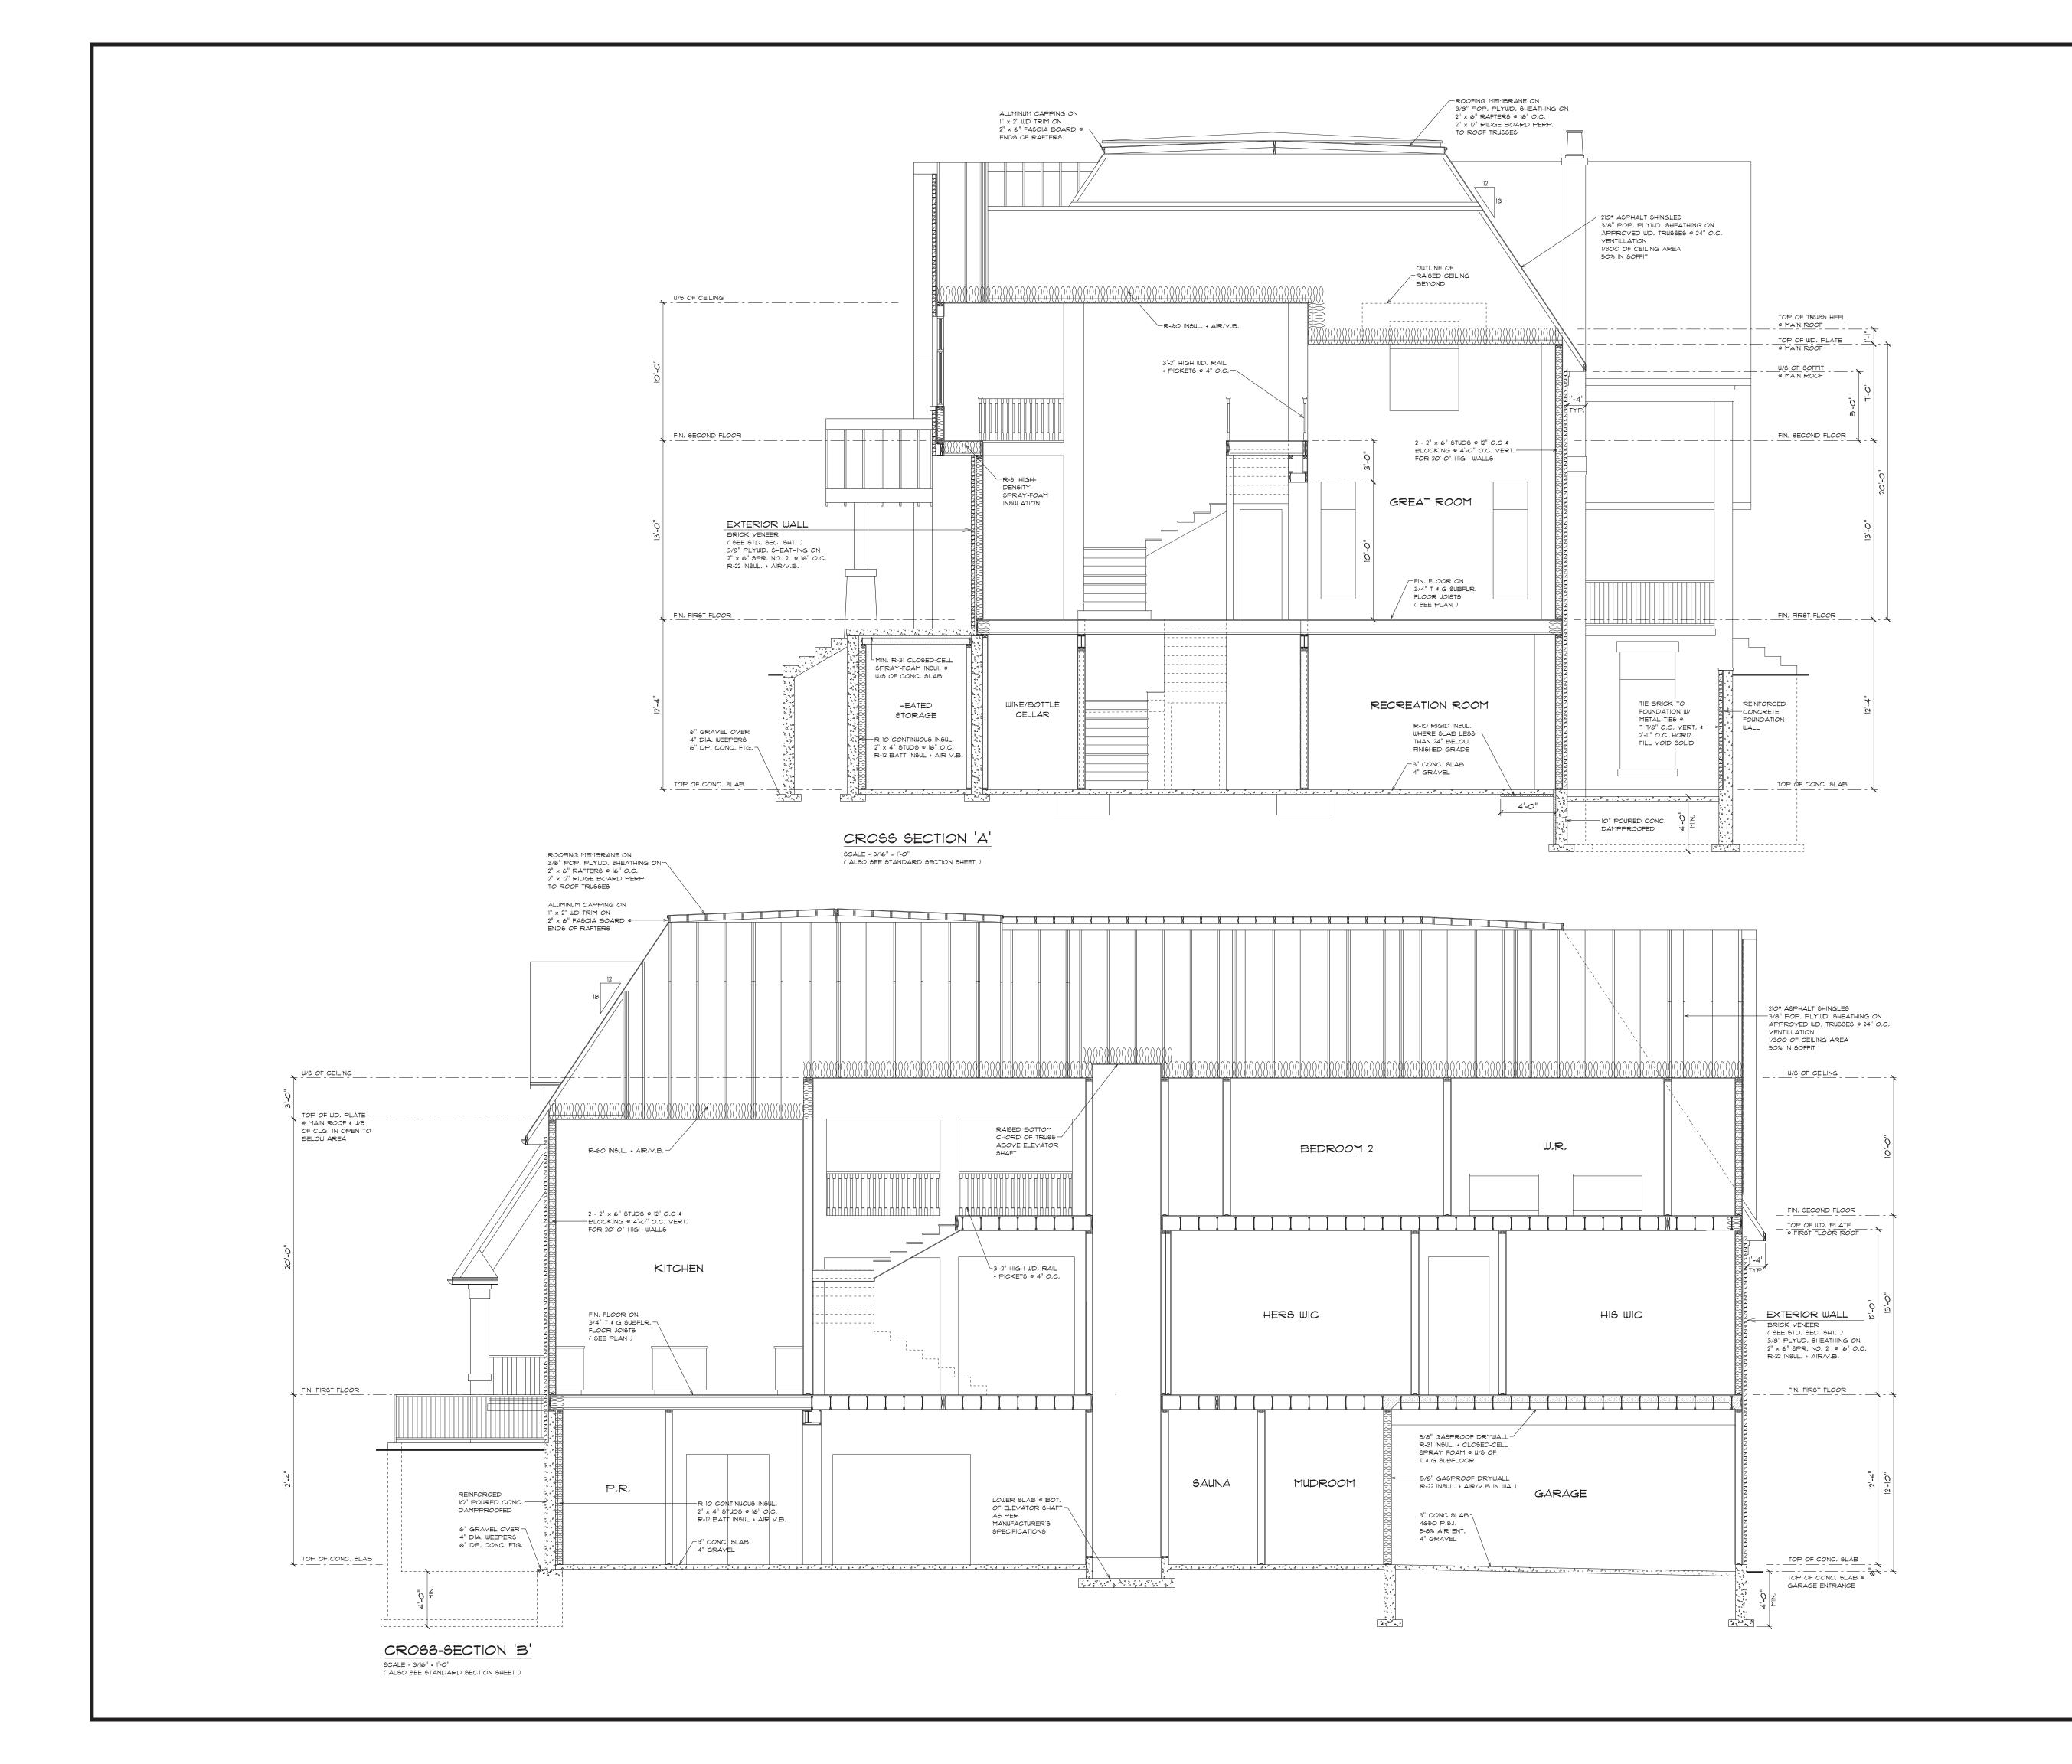

NOTES :

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Do not scale drawings.

Joists to be at 12" O.C. where

BCIN INFORMATION :

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supporting ceramic tile.

Ontario Building Code to be a designer

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the requirements set out in the

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Dean Ruffolo 23

and has the qualifications and meets

REGISTRATION INFORMATION
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of the Ontario Building Code.

Dero Building Designs Consultants Inc. 28

Dero Building Designs Consultants Inc. 28051
FIRM NAME BCIN
This Certification is NOT valid unless accompanied by an original signature.

STRUCTURAL CTAMP

STRUCTURAL CTAMP

ROFESSIONAL

REVISION

REVISION

DATE



PROPOSED
TWO STOREY
45 STEEPLECHASE AVE.
AURORA, ON.

FOR

ANIX DEVELOPMENTS

CROSS SECTIONS 'A' & 'B'



Richmond Hill, Ontario L4B 3A8

T 905 889 8434 F 905 889 8435

info@derodesigns.com www.derodesigns.com

DATE
APR 15, 2024

DRAWN BY
D.R.


PROJ. NO.

SCALE
3/16" = 1'-0"

CHECKED BY
D.R.

D.R.

DWG. NO.

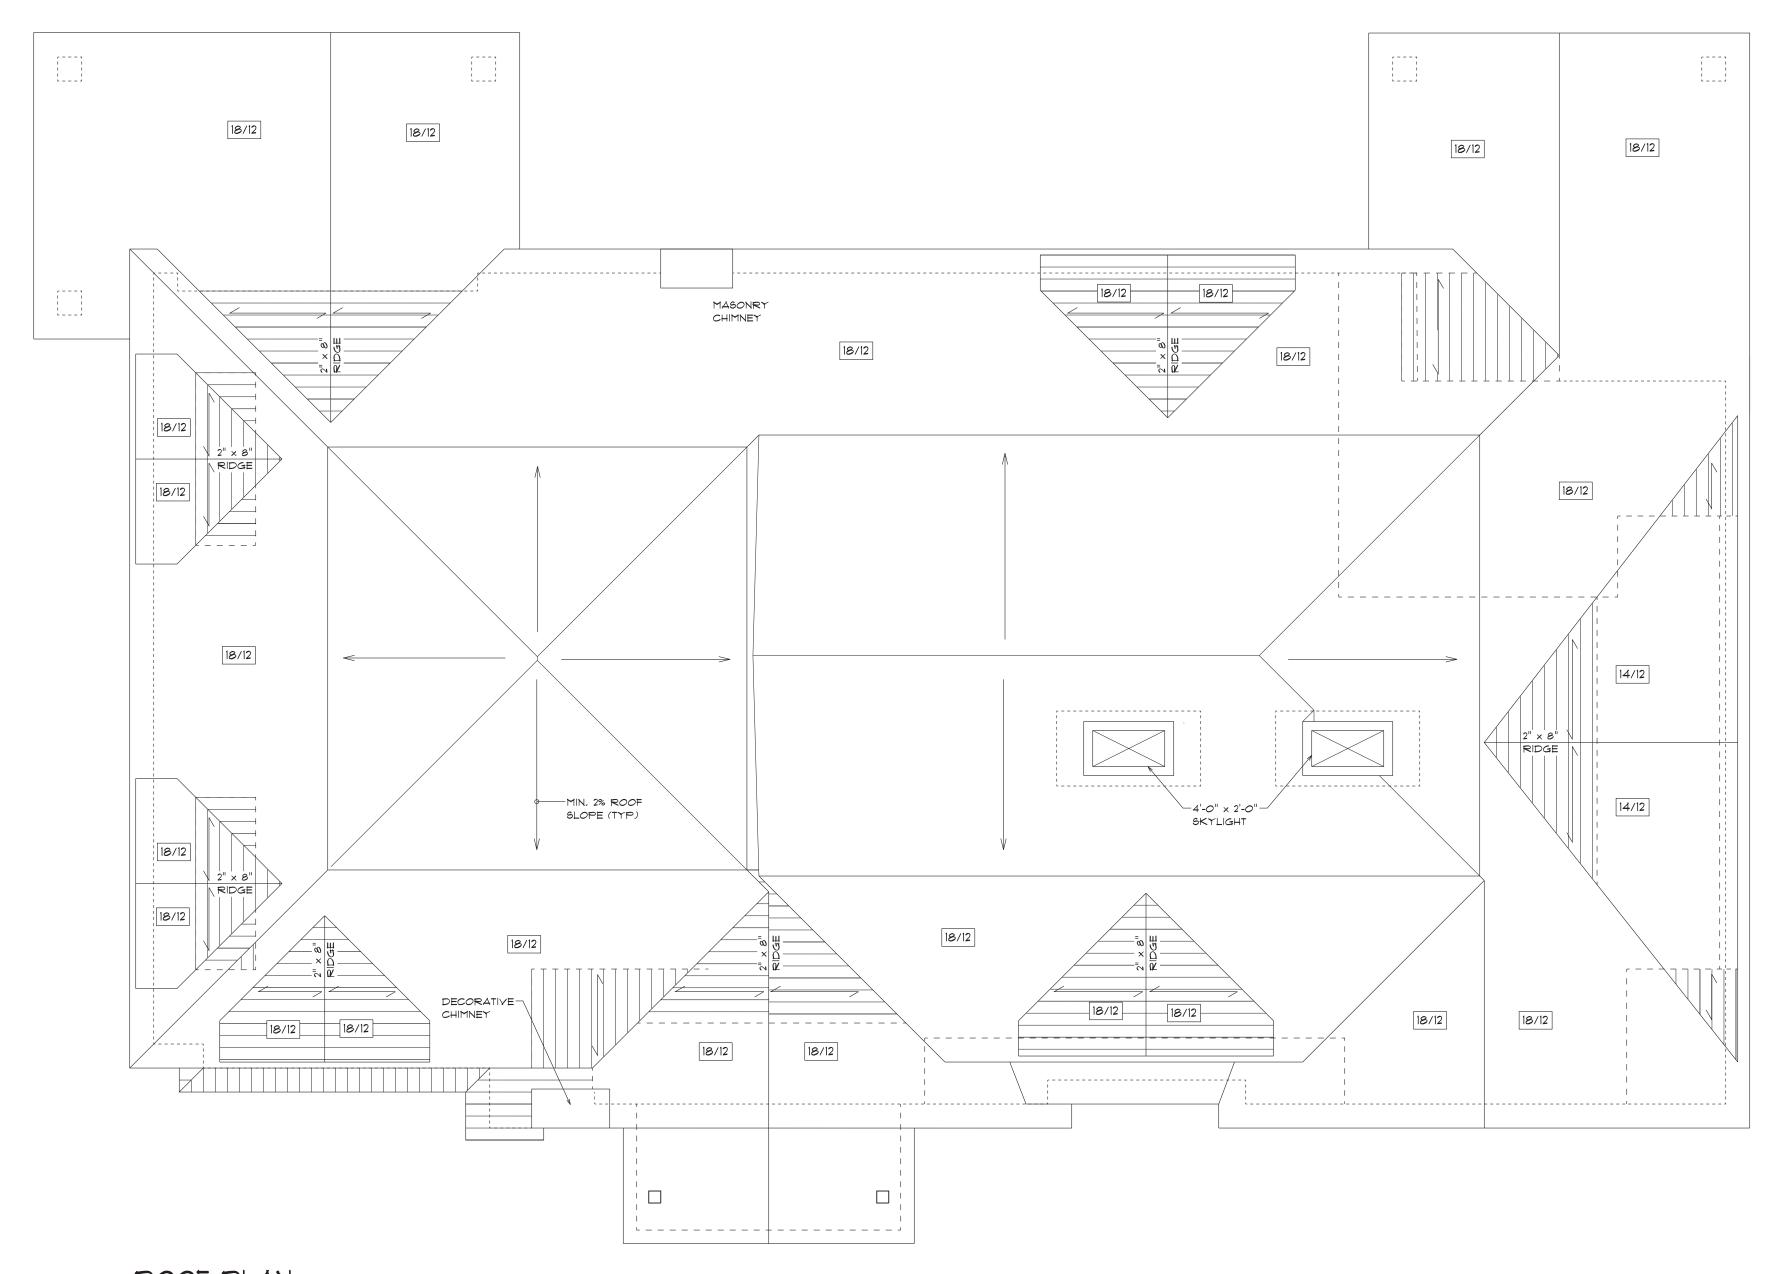

ROOF PLAN SCALE - 3/16" = 1'-0" NOTE - ROOF RAFTERS TO BE 2" x 6" @ 16" O.C. UNLESS OTHERWISE NOTED.

NOTES:

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Do not scale drawings. Joists to be at 12" O.C. where supporting ceramic tile.

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REGISTRATION INFORMATION
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STRUCTURAL STAMP



PROPOSED TWO STOREY 45 STEEPLECHASE AVE. AURORA, ON.

FOR

ANIX DEVELOPMENTS

ROOF PLAN




20 Wertheim Crt. U13 Richmond Hill, Ontario L4B 3A8


T 905 889 8434 F 905 889 8435

info@derodesigns.com www.derodesigns.com


APR 15, 2024 3/16" = 1'-0" DRAWN BY CHECKED BY DWG. NO. PROJ. NO.

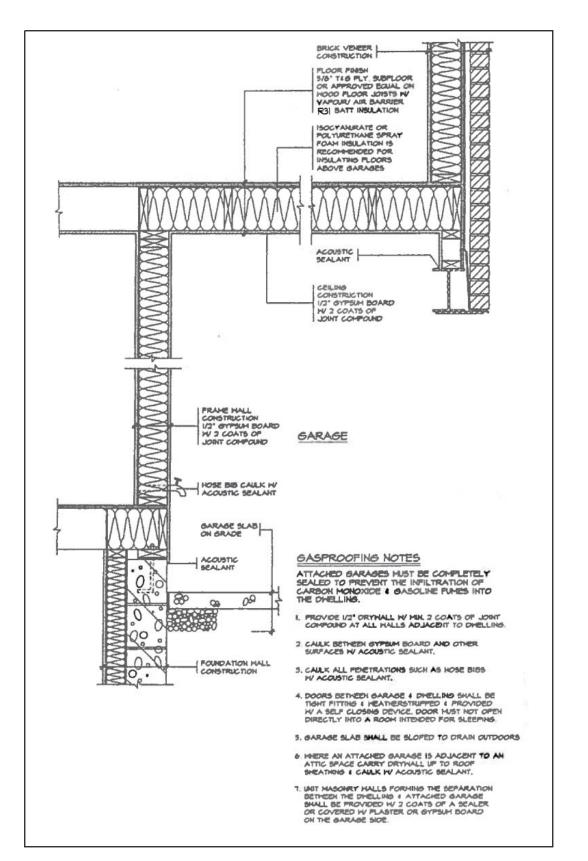


GARAGE GASPROOFING DETAIL (N.T.S.)

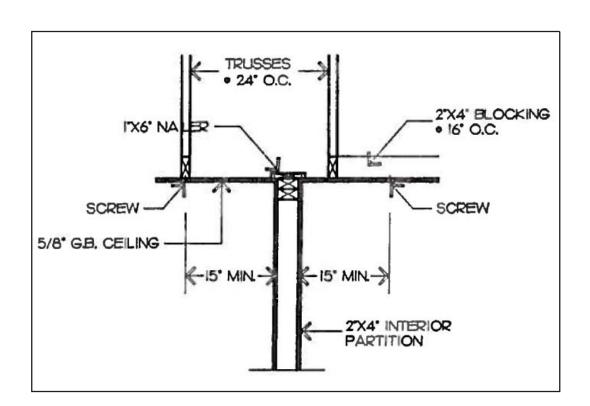


PARTITIONS PARALLEL TO TRUSSES

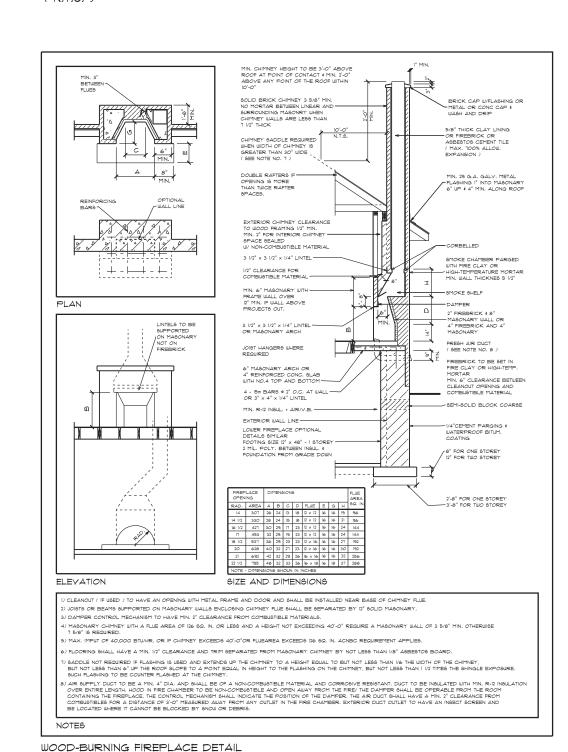


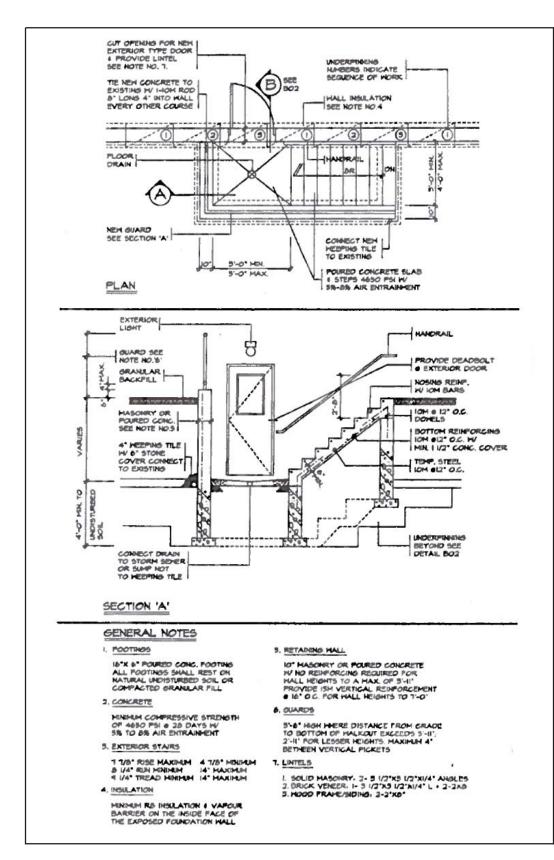

BASEMENT WALK-OUT DETAIL (N.T.S.)

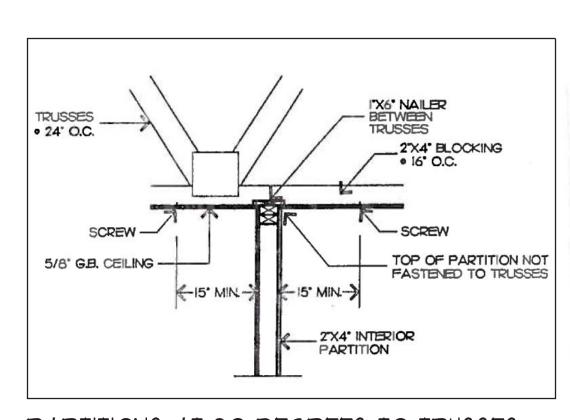


PARTITIONS AT 90 DEGREES TO TRUSSES (N.T.S.)

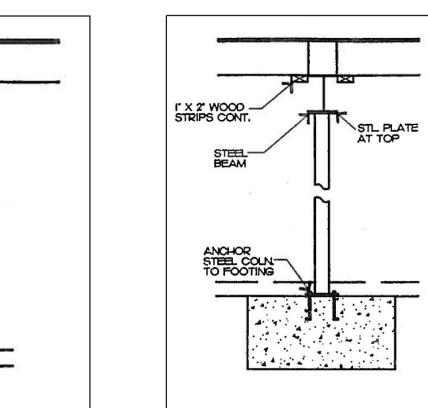


SECTION AT BEARING STUD PARTITION

(N.T.S.)

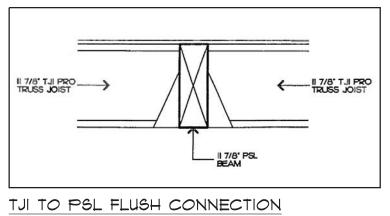

SECTION AT STL. PIPE COLUMN (N.T.S.)

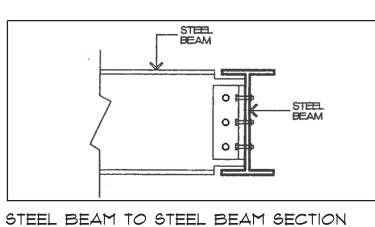

) STRUCTURAL COMPONENTS ARE DESIGNED FOR THE FOLLOWING LOADS IN POUNDS PER SQUARE FOOT. FRAMING LIVE DEAD ROOF TRUSS TOP CHORD 26 10 ROOF TRUSS BOT, CHORD N/A ROOF CONY, B/U

ATTIC CONY, B/U 60 STONE OR 20 STUCCO 24 WIND SECOND FLOOR 40 FIRST FLOOR 40 BALCONYS AND DECKS 50 VARIES

ASSUMED SOIL BEARING CAPACITY FOR FOOTING USED = 3000 PSF. GEOTECHNICAL SOILS INVESTIGATION/REPORT WAS NOT AVAILABLE AT THE TIME OF STRUCTURAL DESIGN, A GEOTECHNICAL ENGINEER SHALL CONFIRM/VERIFY SOIL CONDITIONS UNDER FOOTINGS PRIOR TO PLACEMENT, IF SOIL CONDITIONS AREA FOUND TO DIFFER FROM ASSUMED, THEN ADDITIONAL DESIGN AND/OR CONSTRUCTION COSTS AND/OR DELAYS MAY RESULT.

2) FOR ROOF FRAMING

RAFTERS TO BE 2" x 6" @ 16" O.C. *2 SPF UNLESS NOTED ON ARROW (U/N) RIDGES, HIPS AND VALLEYS TO BE 1-2"x10" #2 SPF U/N. POSTS INDICATED BY SMALL SQUARE TO BE 2-2"x4" UP TO 6'-0" LONG. 3-2"x4" UP TO 10'-0", 3-2"x6" UP TO 14'-0" DOWN TO SUPPORT BELOW. NAIL WITH 2-3 1/2" AT 18" O.C. OR 2-3 AT 12" O.C. (4000 LBS). KNEEWALLS (K.W) TO BE 2"x4" AT 16" O.C. WITH 2"x4" RIBBONS AT 4'-0" O.C. TIE WITH CEILING WHEN SLOPED FOR WALLS OVER 9'-0" HIGH USE 2"x6" STUDS AT 16" O.C. CEILING JOISTS TO BE 2"x6" AT 16" O.C. #2 SPF. U/N.

3) FLOOR JOISTS TO BE II 7/8" TJI AT 16" O.C. U/N WITH BRIDGING AT MID, SPAN,

4) LYL TO BE 2665 F - 2E MINIMUM.

5) STRUCTURAL STEEL TO BE G40.12-350W EXCEPT PIPE COLUMNS WHICH MAY BE A-36 MINIMUM.

6) FASTEN LAMINATIONS IN COLUMNS AND BEAMS WITH 2-3 1/2" AT 18" O.C.

7) WIND LOAD DIAPHRAGM IN WALLS

EXTERIOR WALLS FROM FOUNDATION TO SECOND FLOOR, PLUS INTERIOR GARAGE WALLS, PLUS WALLS MARKED S/W ON PLANS MUST HAVE 1/2" PLYWOOD ON ONE SIDE WITH ALL EDGES NAILED WITH 8D (2 1/2" COMMON) AT 3" O.C. (CAPACITY 450 PLF), USE 2"x4" FLAT BETWEEN STUDS,

CONNECT TOP AND BOTTOM OF WALL WITH 3" COMMON AT 5" O.C. OR 1/2" DIA, ANCHORS AT 32" O.C. SEE PLANS FOR SIMPSON HOLDOWNS (PHD OR HD6) 7/8" DIA,x16"

EMBEDDED IN CONCRETE AND 2-7/8" DIA, OR 18-1/4" DIA, x3" WOOD SCREWS THROUGH OR INTO 3 STUDS MIN. (5000 LBS.)

8) ANCHORAGE FOR WIND UPLIFT (15 PSF) AT EACH SUPPORT

FOR SMALL BEAMS AND RAFTERS USE 3-3 1/4 TOENAILS, FOR WOOD BEAMS OF 3/2"XIO" AND LARGER USE 3-3 1/4" TOENAILS AND SIMPSON H2.5 (8-8D NAILS) FOR LYL IN ROOF USE 4-3 1/4" TOENAILS.

AND SIMPSON PHD2 OR HD2 (5/8" DIA, BOLT) TO COLUMN AND SECOND FLOOR FRAMING. ALTERNATIVE FOR PHD2 USE STRAP 3"x16" GA. WITH 42-16D NAILS (SIMPSON MST C40)

9) SHOP AND ERECTION DRAWINGS FOR STRUCTURAL STEEL PRECAST CONCRETE, OPEN WEB STEEL JOISTS, GUARDS, HANDRAILS, STAIRS, FIRE ESCAPES, ENGINEERED FLOOR FRAMING PRODUCTS AND SYSTEMS (FOR EXAMPLE: T.J.I.'S, A.J.'S, L.V.L.'S, ETC) SHALL BE:

1) DESIGNED IN ACCORANCE WITH THE ONTARIO BUILDING CODE. 2) SEALED BY A REGISTERED PROFESSIONAL ENGINEER, ONTARIO 3) SUBMITTED TO BELBETH ENGINEERING INC. FOR REVIEW PRIOR TO FABRICATION OR ERECTION.

TYP.

ALUMINUM BASE & SNAP CAP

TYPICAL STRUCTURAL NOTES

4 - 1/4" x 2-1/4" WEDGE ANCHORS -BOLTS INTO EXISTING CONC. SLAB

 RAILING DESIGN IN ACCORDANCE WITH THE 2006 ONTARIO BUILDING CODE 2. ALL RAILING MATERIAL ALUMINUM


NOTES:

(N.T.S.)

ALLOY 6063-T5


EXISTING CONC. SLAB ----

TYPICAL ALUMINUM RAILING DETAIL

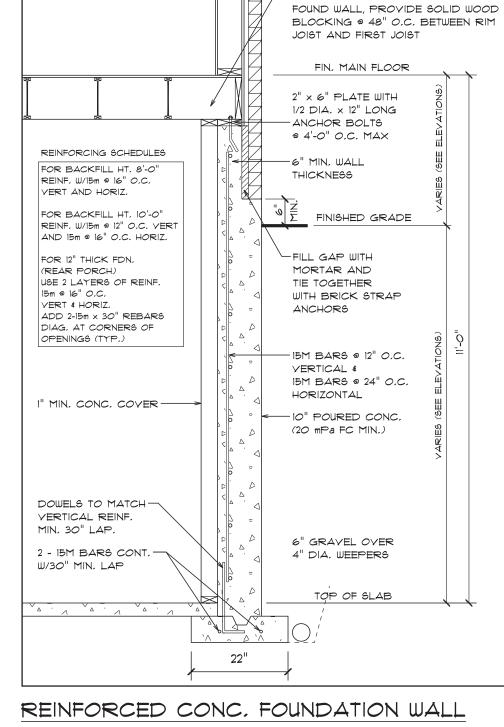

WHERE JOISTS RUN PARALLEL TO

(N.T.S.)

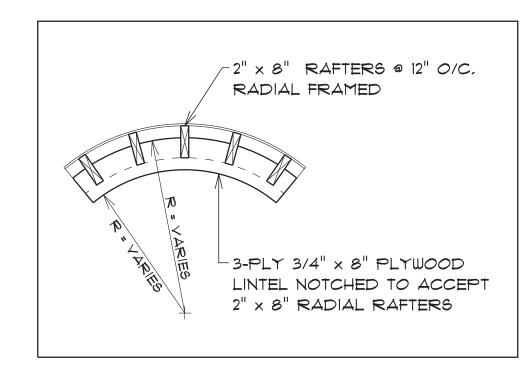

CURYED PLYWOOD LINTEL

TWO #8 HEX SCREWS- 1/4" LONG MATERIAL STEEL (TYP. 4 PLACES)

-3/4"x3/4" ALUM. PICKETS TYP

- CAST ALUMINUM BASE TYP.


-ALUM. POST 3"x3"

----WOOD FRAMING


-4 - 5/16"x 5" LAG

BOLTS (ZINC) INTO 4 - 2"x 6" MIN

-1/2"x3/4" WALL SPINDLE

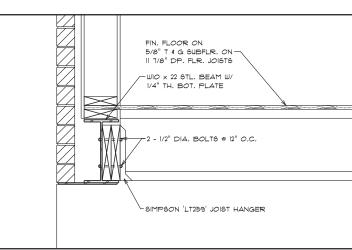

FLUSH STEEL BEAM CONNECTION DETAIL

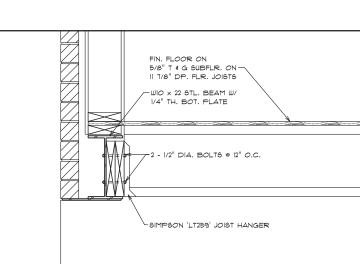



Richmond Hill, Ontario L4B 3A8

T 905 889 8434 F 905 889 8435

info@derodesigns.com www.derodesigns.com

DRAWN BY CHECKED BY DATE DWG. NO. APR 15, 2024

This Certification is NOT valid unless accompanie by an original signature.

DATE

STRUCTURAL SEAL

ANIX

DEVELOPMENTS

PROPOSED TWO STOREY

AURORA, ON.

FOR

ANIX

DETAILS

45 STEEPLECHASE AVE.

DEVELOPMENTS

NOTES

The contractor must check and verify all dimensions and report any discrepancies to the designer before commencing construction.

Joists to be at 12" O.C. where

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the requirements set out in the

Do not scale drawings.

supporting ceramic tile.

