MAIL ROOM OFFICE 0'-0"x0'-0"

GROUND FLOOR PLAN

TYPICAL BASEMENT FLOOR PLAN NOTES

ALL CONCRETE FOOTING SHALL REST ON UNDISTURBED SOIL WITH A MIN. ALLOWABLE BEARING CAPACITY OF 150 Kpa (3000 PSF) AND BE FOUNDED A MIN. OF 4'-0" BELOW FINISHED GRADE.

CONCRETE STRENGTH FOR CONCRETE FOOTINGS SHALL BE MIN. OF **ISMPA.** FOR FOUND. WALLS SHALL BE **25MPA.** UN AND REFER TO TYP. DETAIL CONCRETE STRENGTH FOR GARAGE SLAB, CONCRETE

PORCHES AND STEPS SHALL BE A MIN. 32MPA. WITH 5 - 8% AIR ENTRAINMENT. UNLESS NOTED OTHERWISE.

CONCRETE STRIP FOOTING SIZE FOR 10" P. CONC. WALLS SHALL BE MIN. OF **8"**×22" UNREINFORCED FOR **UP TO 16'-0"** JOIST SPAN.

THE ABOVE FOOTING SIZE WILL BE USED FOR FOUNDATION WALLS WHICH SUPPORT 2 STOREYS OF BRICK VENEER WALL CONSTRUCTION, 2 FLOORS AND ROOF OF LIGHT WOOD FRAME CONSTRUCTION, WITH SPAN OF SUPPORTED JOIST THAT DO NOT EXCEED 4.9m (16'-1") AT A SPECIFIED LIVE LOAD OF NOT GREATER THAN 2.4 Kda (50 PSF).

4.9m (16'-1") AT A SPECIFIED LIVE LOAD OF NOT GREATER THAN 2.4 Kpa (50 PSF). REFER TO BASEMENT PLAN FOR FOOTING SIZES IN AREAS EXCEEDING THE ABOVE CONDITIONS.

3/4" SUB-FLOOR TO BE GLUED & NAILED (TYP.).
REFER JOIST MANUFACTURER'S SPECIFICATIONS
FOR ALL TECHNICAL DETAILS & LAYOUT
ALL JOISTS UNDER CERAMIC TILES TO BE INSTALLED

AS PER JOIST MANUF, SHOP DIUG'S.

ALL LYLS SHALL BE 1.9E GRADE MICROLLAM LYL

OR BETTER U. S. O.

FI= 36"x36"x16"	F2= 24"x24"xl2"
F3= 20"x20"x12"	

ALL RETURN AIR PARTITIONS TO BE 6" - REFER TO HYAC DRAWINGS

BRICK VENEER LINTELS

WL3	=	3 1/2" x 3 1/2" x 1/4" 4" x 3 1/2" x 5/16" 5" x 3 1/2" x 5/16"	(9Øx9Øx6) (1ØØx9Øx8) (125x9Øx8)	÷	2- 2" × 8" 2- 2" × 8" 2- 2" × 10"	SPR SPR SPR
						-, , -
WL4	=	6" x 3 1/2" x 3/8"	(150×90×10)	+	2- 2" x 12"	SPR.
WL5	=	6" x 4" x 3/8"	(150x100x10)	+	2- 2" × 12"	SPR.
WL6	=	5" x 3 1/2" x 5/16"	(125x9Øx8)	+	2- 2" × 12"	SPR.
WLT	=	5" x 3 1/2" x 5/16"	(125x9Øx8)	+	3- 2" x 10"	SPR.
WL8	=	5" x 3 1/2" x 5/16"	(125x9Øx8)	+	3- 2" x 12"	SPR.
WL9	=	6" x 4" x 5/16"	(150x100x10)	+	3- 2" x 12"	SPR.

WOOD LINTELS AND BEAMS

WBI	=	2- 2" x 8"	SPRUCE BEAN
WB2	=	3- 2" x 8"	SPRUCE BEAT
WB3	=	2- 2" x 10"	SPRUCE BEAT
WB4	=	3- 2" x 10"	SPRUCE BEAT
WB5	=	2- 2" x 12"	SPRUCE BEAT
WB6	=	3- 2" x 12"	SPRUCE BEAT
WBT	=	5- 2" x 12"	SPRUCE BEAT
WBII	=	4- 2" x 10"	SPRUCE BEAN
WB12	=	4- 2" x 12"	SPRUCE BEAT

STEEL LINTELS

L1	=	3 1/2" x 3 1/2" x 1/4"	(89x89x6.4)
L2	=	4" x 3 1/2" x 5/16"	(1 <i>0</i> 2x89x7.9)
L3	=	5" x 3 1/2" x 5/16"	(127x89x7.9)
L4	=	6" x 3 1/2" x 3/8"	(152x89x9.5)
L5	=	6" x 4" x 3/8"	(152x1Ø2x9.5)
L6	=	7" x 4" x 3/8"	(178x1Ø2x9.5)
L٦	=	7" ×4" × 1/2"	(1 78x10 2x13)

(LVL) BEAMS

LVLIA	=	1-1 3/4" x 7 1/4"	(1-45x184)
LVLI	=	2-l 3/4" x T 1/4"	(2-45x184)
LVL2	=	3-l 3/4" x 7 l/4"	(3-45xl84)
LVL3	=	4-l 3/4" x 7 l/4"	(4-45x184)
LVL4A	=	1-1 3/4" x 9 1/2"	(1-45x235)
LVL4	=	2-13/4" x 9 1/2"	(2-45x235)
LVL5	=	3-1 3/4" x 9 1/2"	(3-45x235)
LVL5A	=	4-1 3/4" x 9 1/2"	(4-45x235)
LVL6A	=	1-1 3/4" x 11 7/8"	(1-45x3 <i>00</i>)
LVL6	=	2-1 3/4" x 11 7/8"	(2-45x3 <i>00</i>)
LVLT	=	3-1 3/4" x 11 7/8"	(3-45x3 <i>00</i>)
LVL7A	=	4-1 3/4" x 11 7/8"	(4-45x3 <i>00</i> 0)

COMPLIANCE PACKAGE "A1"

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Contractor shall check all dimensions on the work and report any discrepancy to the Architectural Technologist before proceeding. Construction must conform to all applicable Codes and Requirement of Authorities having Jurisdiction.

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This drawing is not to be scaled.

This drawing is not to be used for construction unless signed by the Architectural Technologist.

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2.	OCT. 1/24	REV. TILE BLOCK TO 5 STOREY BUILDING
1.	AUG. 26/24	ISSUED FOR REVIEW
NO:	DATE:	REVISION:



RAWING TITLE:

EXISTING GROUND FLOOR PLAN



P <u>DEL DESIGN</u>

Suite 203 Woodbridge, Ontario L4L 4Y4

T: 416 453 9985 e-mail: peterd@pdeldesign.ca www.pdeldesign.ca

4370 Steeles Avenue West,

The undersigned has reviewed and takes responsibility for this design, and has the qualifications and meets the requirements set out in the Ontario Building Code to design the work shown on the

attached documents QUALIFICATION INFORMATION


Required unless design is exempt under Division C, Subsection 3.2.5 of The Building Code

PETER DEL GROSSO 209

REGISTRATION INFORMATION

Required unless design is exempt under

Division C, Subsection 3.2.4 of The Building Code

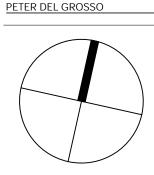



PROJE

PROPOSED 5 STOREY BUILDING

15 TYLER STREET AURORA, ONTARIO


AREA: [SCALE: 3/16"=1'-0" [

DATE: JULY 26/24
3/16"=1'-0" **DRAWN BY:** PDG

DRAWING No.:

A-01

PROJECT No.: 00-00

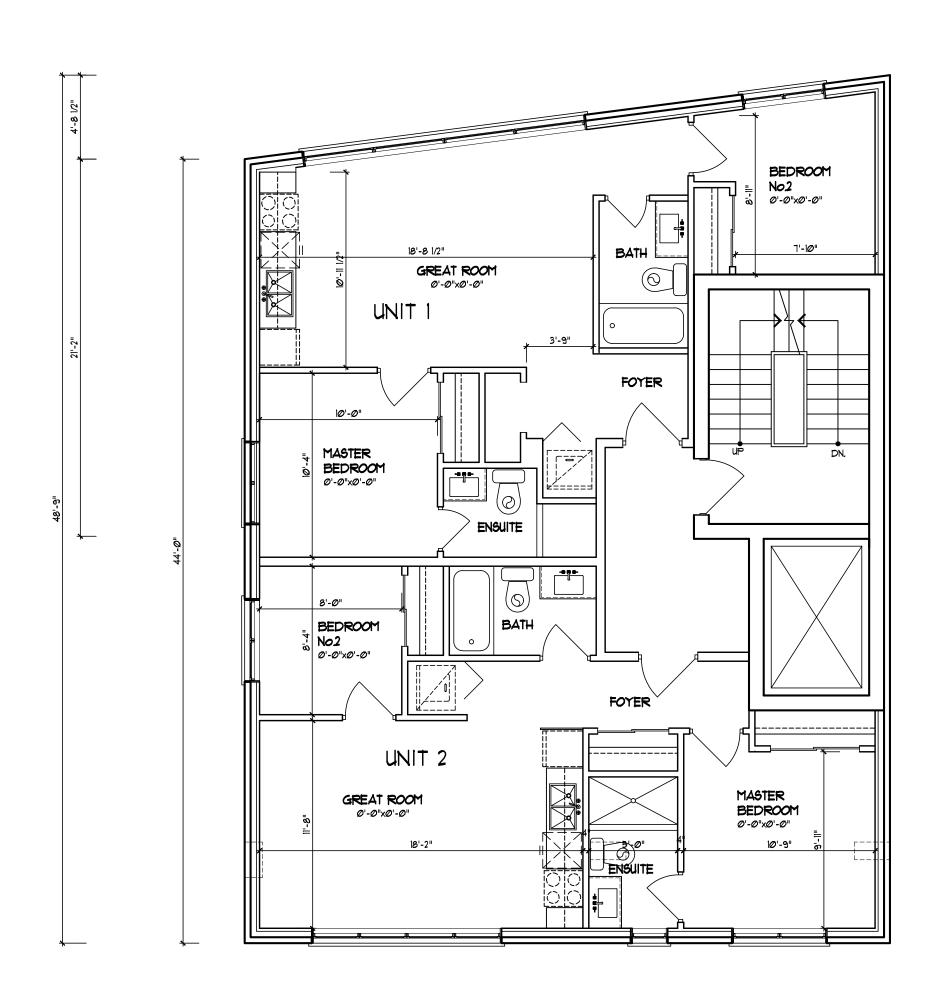

36'-3"

SECOND/THIRD FLOOR PLAN

TYPICAL GROUND FLOOR NOTES

- REFER JOIST MANUFACTURER'S SPECIFICATIONS FOR ALL TECHNICAL DETAILS & LAYOUT
- 3/4" SUB-FLOOR TO BE GLUED & NAILED FOR GROUND FLOOR 5/8" SUB-FLOOR FOR SECOND FLOOR (TYP.)
- ALL JOISTS UNDER CERAMIC TILES TO BE INSTALLED AS PER JOIST MANUF. SHOP DIUG'S.
- NO VOLUTE ON STAIRS RAILING
- ALL LVLS SHALL BE 1.9E GRADE MICROLLAM LVL OR BETTER U. S. O.

REFER TRUSS SHOP DIUGS, FOR COMPLETE TRUSS LAYOUT AND SPECIFICATIONS

DENOTES CEILING HEIGHT

ALL RETURN AIR PARTITIONS TO BE 6" - REFER TO HVAC DRAWINGS

AREA CALCULATION

UNIT 1

UNIT 2

SUBTOTAL

DEDUCT ALL OPEN AREAS

COMMERCIAL AREA

COVERAGE GROUND FLOOR

COVERAGE RESIDENTIAL UNITS

TOTAL NET AREA

711 SQ. FT.

677 SQ. FT.

1388 SQ. FT.

Ø 5Q. FT.

1388 SQ. FT.

465 SQ. FT.

1014 SQ. FT.

9420 M2

1680 SQ. FT. 156.08 M2

128.95 M2

128.95 M2

COMPLIANCE PACKAGE "A1"

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2.	OCT. 1/24	REV. TILE BLOCK TO 5 STOREY BUILDING
1.	AUG. 26/24	ISSUED FOR REVIEW
NO:	DATE:	REVISION:



PROPOSED SECOND/THIRD FLOOR



4370 Steeles Avenue West,

Suite 203 Woodbridge, Ontario L4L 4Y4 T: 416 453 9985

e-mail: peterd@pdeldesign.ca www.pdeldesign.ca

The undersigned has reviewed and takes responsibility for this design, and has the qualifications and meets the requirements set out in the Ontario Building Code to design the work shown on the attached documents

QUALIFICATION INFORMATION


Required unless design is exempt under Division C, Subsection 3.2.5 of The Building Code

PETER DEL GROSSO

REGISTRATION INFORMATION

Required unless design is exempt under

Division C, Subsection 3.2.4 of The Building Code

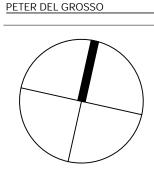



PROPOSED 5 STOREY BUILDING

15 TYLER STREET AURORA, ONTARIO

AREA: DATE: JULY 26/24


3/16"=1'-0" DRAWING No.:

SCALE:

DRAWN BY: PDG

A-02

PROJECT No.: 00-00

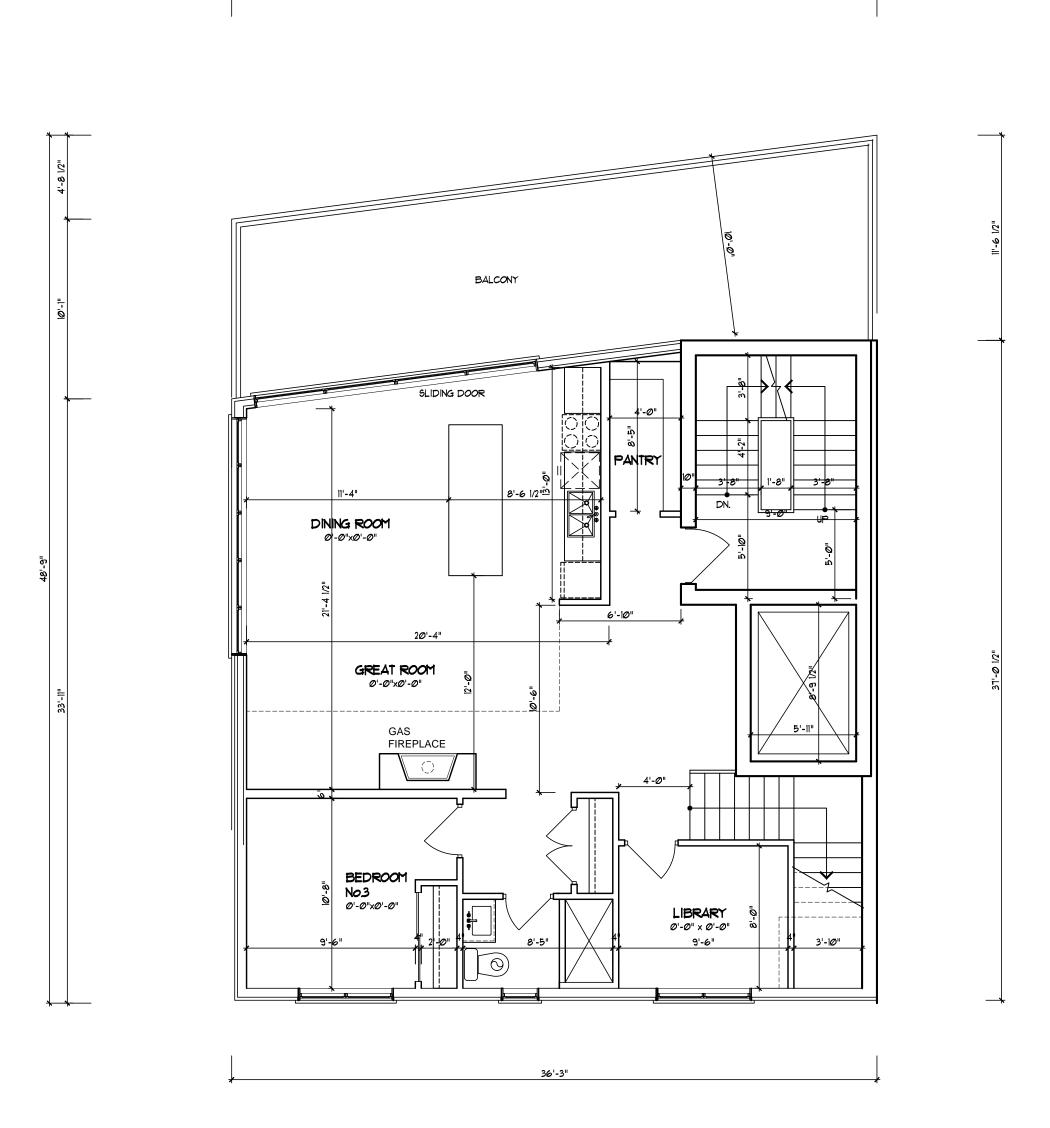

FORTH FLOOR GROUND FLOOR PLAN

AREA CALCULATION GROUND FLOOR AREA 1096 SQ. FT. 800 SQ. FT. MEZZANINE AREA 1896 SQ. FT. SUBTOTAL 176.14 M2 DEDUCT ALL OPEN AREAS Ø SQ. FT. 1896 SQ. FT. TOTAL NET AREA 176.14 M2 COMMERCIAL AREA 465 SQ. FT.

COVERAGE GROUND FLOOR

COVERAGE RESIDENTIAL UNITS

1014 SQ. FT.

1680 SQ. FT.

94.20 M2

156.08 M2

COMPLIANCE PACKAGE "A1"

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2.	OCT. 1/24	REV. TILE BLOCK TO 5 STOREY BUILDING
1.	AUG. 26/24	ISSUED FOR REVIEW
NO:	DATE:	REVISION:



PROPOSED FORTH GROUND FLOOR



4370 Steeles Avenue West,

Suite 203 Woodbridge, Ontario L4L 4Y4 T: 416 453 9985

e-mail: peterd@pdeldesign.ca www.pdeldesign.ca

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QUALIFICATION INFORMATION


Required unless design is exempt under

Division C, Subsection 3.2.5 of The Building Code

PETER DEL GROSSO

REGISTRATION INFORMATION Required unless design is exempt under

Division C, Subsection 3.2.4 of The Building Code

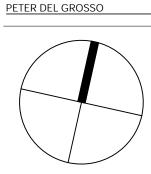



PROPOSED 5 STOREY BUILDING

15 TYLER STREET AURORA, ONTARIO

AREA: **DATE:** JULY 26/24 DRAWN BY: PDG SCALE: 3/16"=1'-0"


DRAWING No.:

A-03

SECOND FLOOR PLAN

PROJECT No.:

00-00

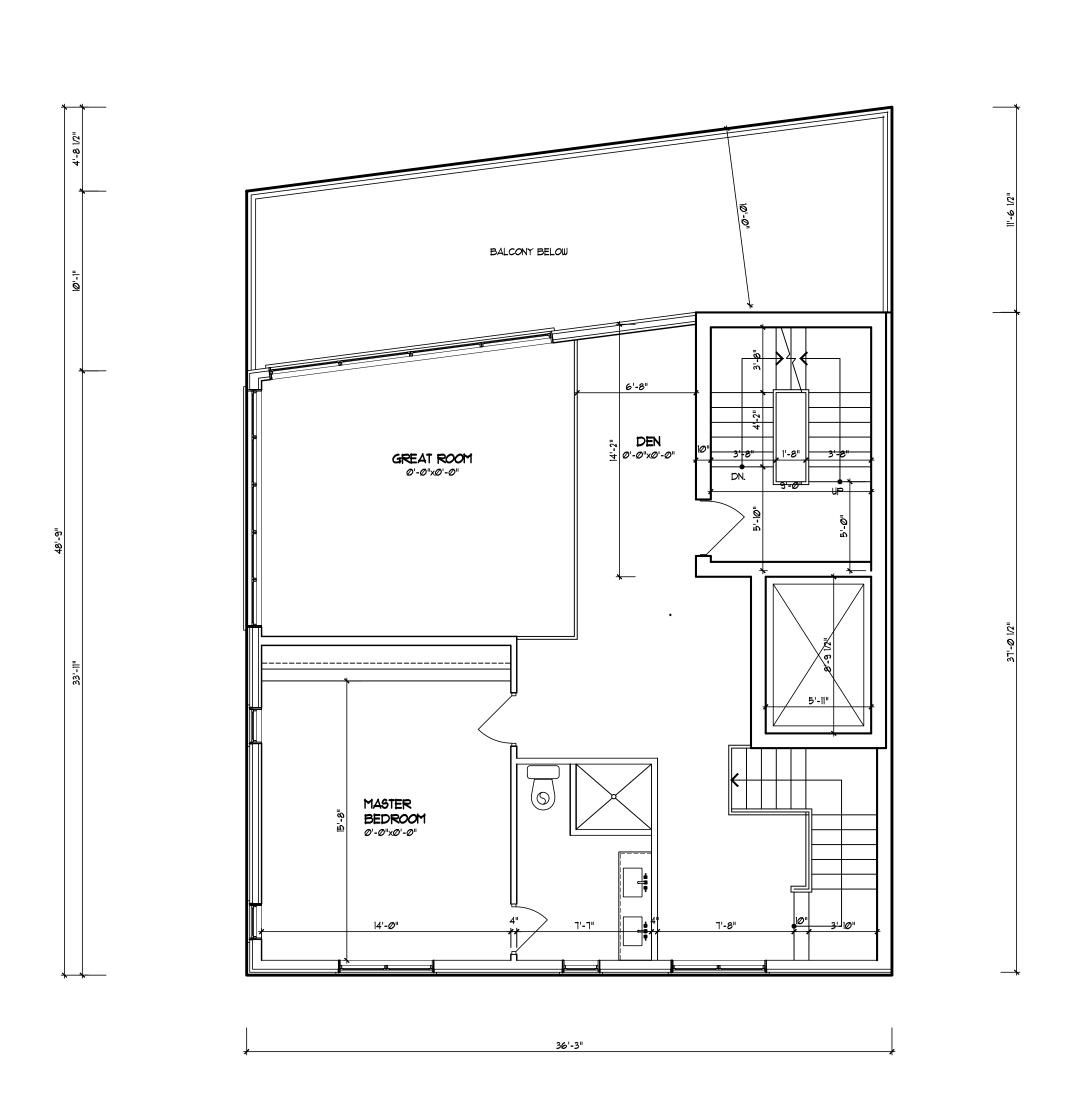

FORTH FLOOR MEZZANINE FLOOR PLAN

COMPLIANCE PACKAGE "A1"

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This drawing is not to be scaled.

REFER TRUSS SHOP DWGS. FOR COMPLETE

TRUSS LAYOUT AND SPECIFICATIONS


9'-0" DENOTES CEILING HEIGHT

ALL RETURN AIR PARTITIONS TO BE 6"

- REFER TO HYAC DRAWINGS

This drawing is not to be used for construction unless signed by

the Architectural Technologist. DENOTES STUD WALL REINFORCED FOR FUTURE GRAB BARS, REFER TO DETAIL 6/D-3 2. OCT. 1/24 REV. TILE BLOCK TO 5 STOREY BUILDING 1. AUG. 26/24 ISSUED FOR REVIEW

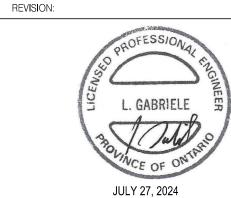

NO: DATE:

PROPOSED MEZZANINE FLOOR



P DEL DESIGN

4370 Steeles Avenue West, Suite 203 Woodbridge, Ontario L4L 4Y4

T: 416 453 9985 e-mail: peterd@pdeldesign.ca www.pdeldesign.ca

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QUALIFICATION INFORMATION


Required unless design is exempt under Division C, Subsection 3.2.5 of The Building Code


PETER DEL GROSSO

REGISTRATION INFORMATION

Required unless design is exempt under Division C, Subsection 3.2.4 of The Building Code

PETER DEL GROSSO

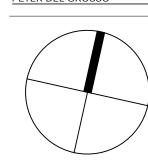

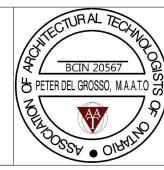

PROPOSED 5 STOREY BUILDING

15 TYLER STREET AURORA, ONTARIO

AREA: **DATE:** JULY 26/24 SCALE: DRAWN BY: PDG 3/16"=1'-0"


DRAWING No.:

A-04

PROJECT No.:

00-00

SECOND FLOOR PLAN

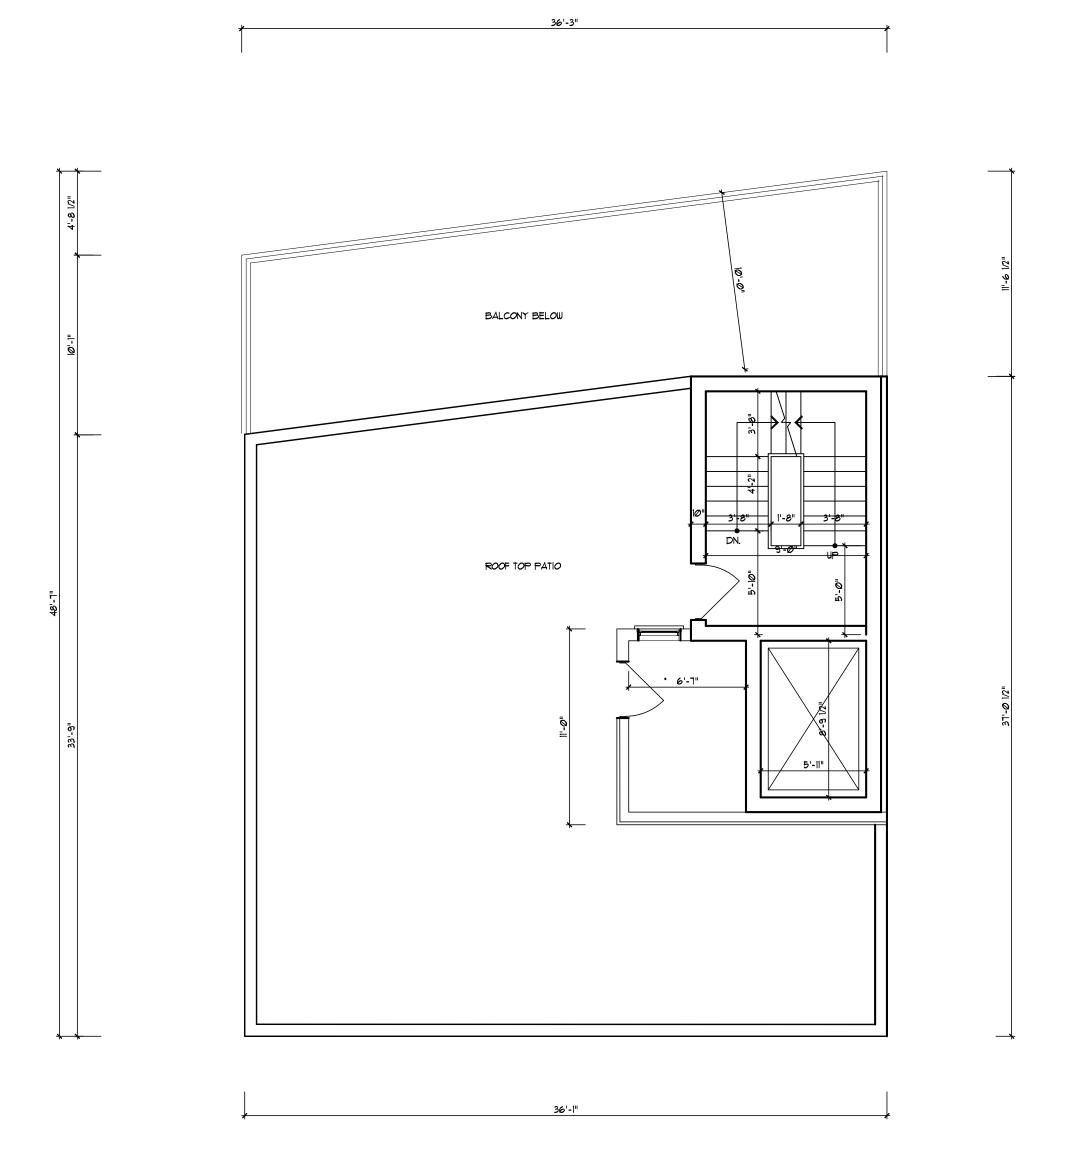

ROOF TOP FLOOR PLAN

COMPLIANCE PACKAGE "A1"

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This drawing is not to be scaled.

REFER TRUSS SHOP DWGS. FOR COMPLETE

DENOTES STUD WALL REINFORCED FOR FUTURE GRAB BARS, REFER TO DETAIL 6/D-3

TRUSS LAYOUT AND SPECIFICATIONS


9'-0" DENOTES CEILING HEIGHT

- REFER TO HVAC DRAWINGS

ALL RETURN AIR PARTITIONS TO BE 6"

This drawing is not to be used for construction unless signed by the Architectural Technologist.

2. OCT. 1/24 REV. TILE BLOCK TO 5 STOREY BUILDING 1. AUG. 26/24 ISSUED FOR REVIEW

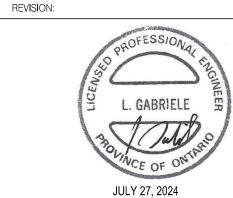

NO: DATE:

PROPOSED ROOF TOP PATIO



P DEL DESIGN

4370 Steeles Avenue West, Suite 203 Woodbridge, Ontario L4L 4Y4 T: 416 453 9985

e-mail: peterd@pdeldesign.ca www.pdeldesign.ca

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OUALIFICATION INFORMATION


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PROPOSED 5 STOREY BUILDING

15 TYLER STREET AURORA, ONTARIO

AREA: **DATE:** JULY 26/24 DRAWN BY: PDG SCALE:

DRAWING No.:

A-05

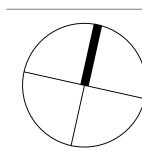PROJECT No.:

SECOND FLOOR PLAN

00-00



REFER TO TRUSS SHOP DIUGS. FOR COMPLETE TRUSS LAYOUT AND SPECIFICATIONS

REFER TO JOIST MANUFACTURER'S SPECIFICATIONS FOR ALL TECHNICAL DETAILS & INFO.

ACTUAL FINISH GRADES MAY VARY DEPENDING ON LOT CONDITIONS, (REFER TO GRADING PLANS)

RAILING REQUIRED WHEN GRADE 16 MORE THAN 2'-0"

COMPLIANCE PACKAGE "A1"

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2.	OCT. 1/24	REV. TILE BLOCK TO 5 STOREY BUILDING
1.	AUG. 26/24	ISSUED FOR REVIEW
NO:	DATE:	REVISION:



NORTH (FRONT) ELEVATION



P DEL DESIGN

4370 Steeles Avenue West, Suite 203

Woodbridge, Ontario L4L 4Y4 T: 416 453 9985 e-mail: peterd@pdeldesign.ca www.pdeldesign.ca

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OUALIFICATION INFORMATION


Required unless design is exempt under Division C, Subsection 3.2.5 of The Building Code

PETER DEL GROSSO

REGISTRATION INFORMATION

Required unless design is exempt under Division C, Subsection 3.2.4 of The Building Code

PETER DEL GROSSO

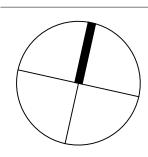



PROPOSED 5 STOREY BUILDING

15 TYLER STREET AURORA, ONTARIO

AREA: **DATE:** JULY 26/24 SCALE: DRAWN BY: PDG

DRAWING No.:

A-06

PROJECT No.: 00-00



REFER TO TRUSS SHOP DILGS. FOR COMPLETE TRUSS LAYOUT AND SPECIFICATIONS

REFER TO JOIST MANUFACTURER'S SPECIFICATIONS FOR ALL TECHNICAL DETAILS & INFO.

ACTUAL FINISH GRADES MAY VARY DEPENDING ON LOT CONDITIONS. (REFER TO GRADING PLANS)

RAILING REQUIRED WHEN GRADE IS MORE THAN 2'-0"

COMPLIANCE PACKAGE "A1"

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2.	OCT. 1/24	REV. TILE BLOCK TO 5 STOREY BUILDING
1.	AUG. 26/24	ISSUED FOR REVIEW
NO:	DATE:	REVISION:



WEST (SIDE) ELEVATION



P DEL DESIGN

4370 Steeles Avenue West, Suite 203 Woodbridge, Ontario L4L 4Y4

T: 416 453 9985 e-mail: peterd@pdeldesign.ca www.pdeldesign.ca

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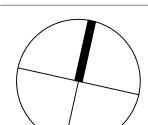
OUALIFICATION INFORMATION


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PETER DEL GROSSO

REGISTRATION INFORMATION Required unless design is exempt under

Division C, Subsection 3.2.4 of The Building Code PETER DEL GROSSO



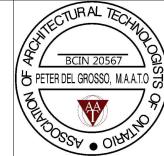

PROPOSED 5 STOREY BUILDING

15 TYLER STREET AURORA, ONTARIO


AREA: **DATE:** JULY 26/24

SCALE: DRAWN BY: PDG

DRAWING No.:

A-07

PROJECT No.: -00-00

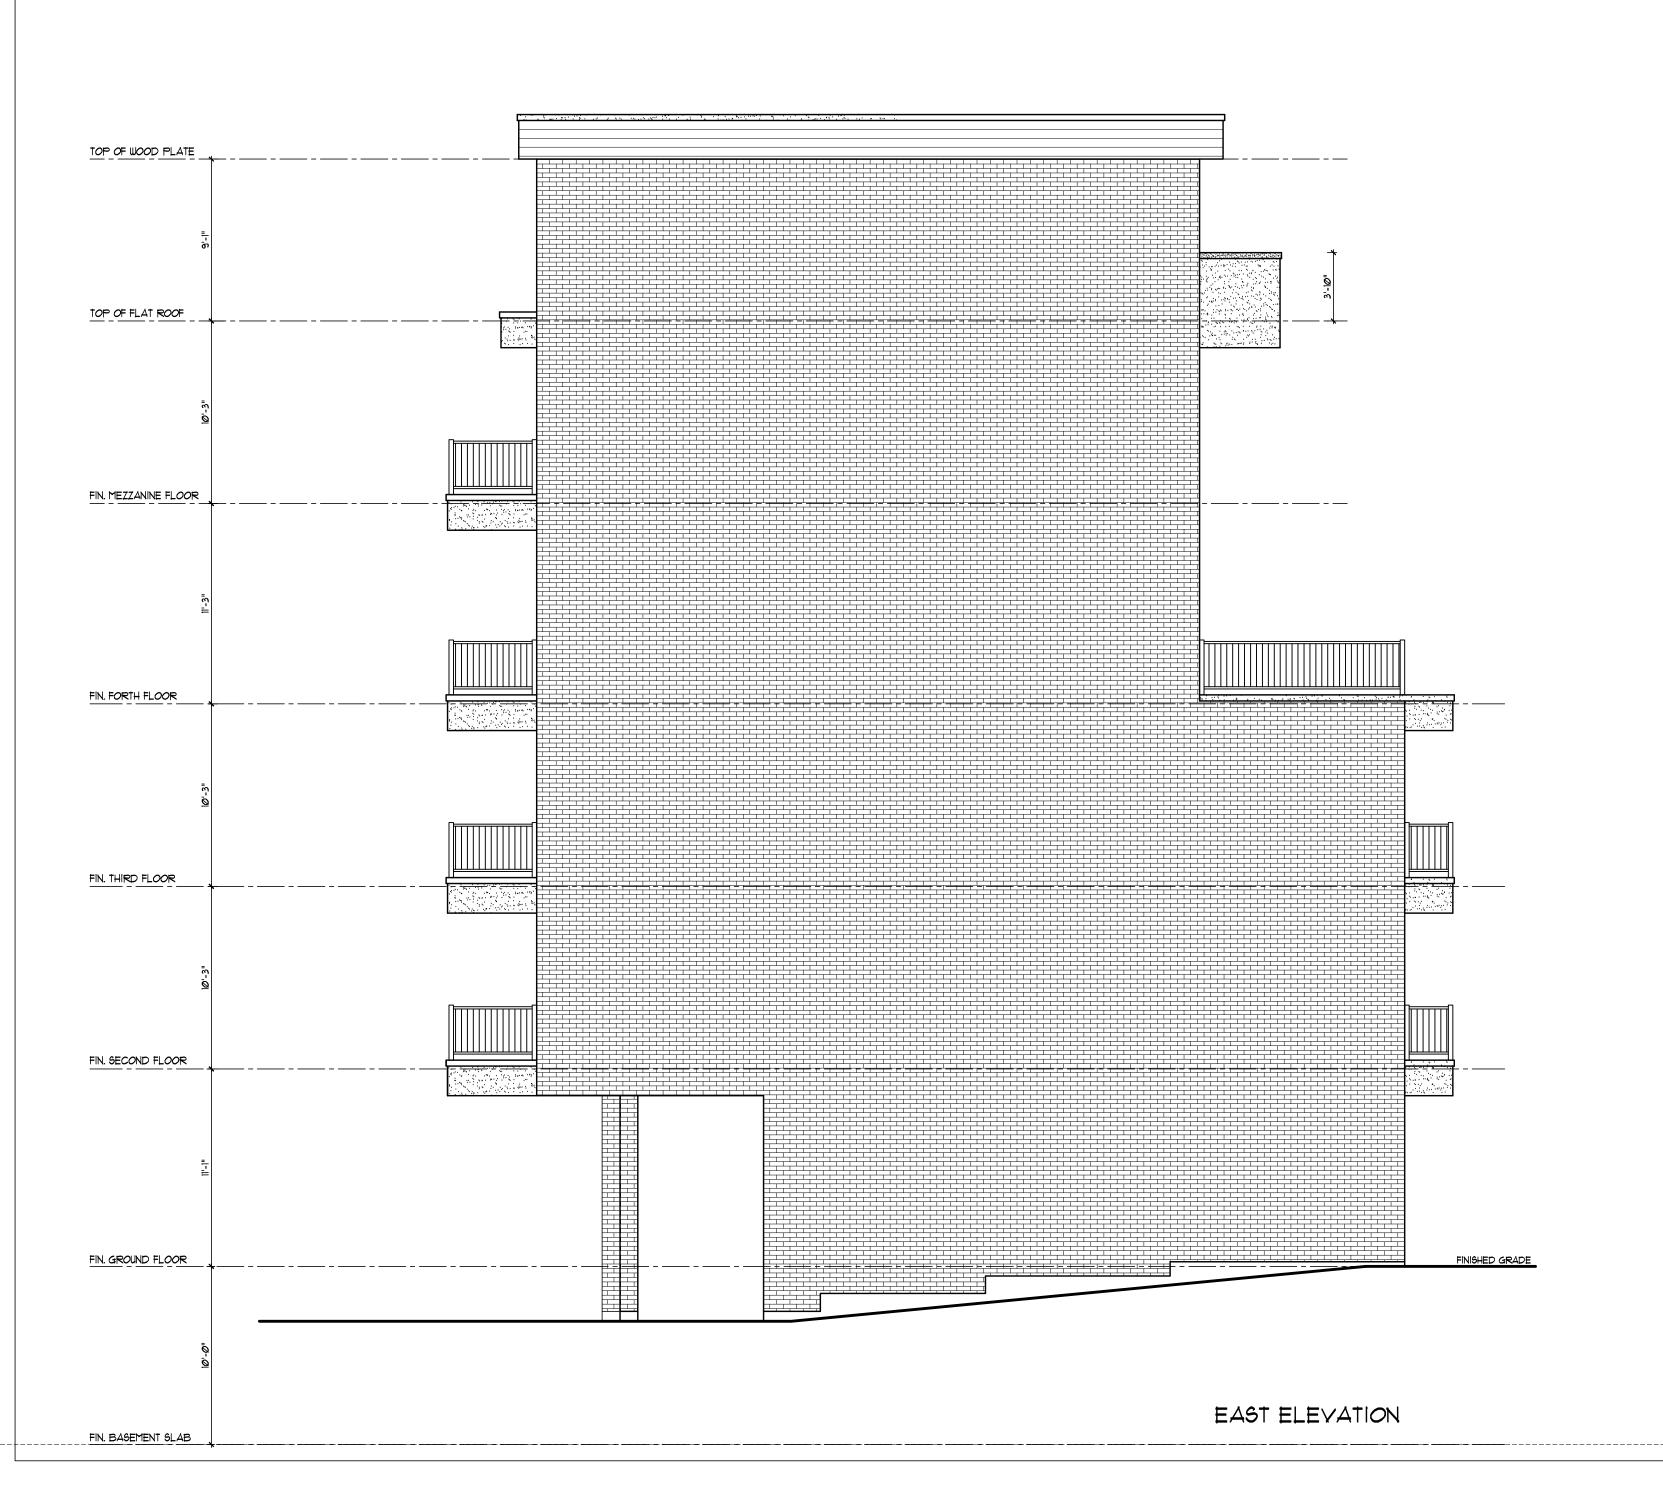

REFER TO TRUSS SHOP DILGS. FOR COMPLETE TRUSS LAYOUT AND SPECIFICATIONS

REFER TO JOIST MANUFACTURER'S SPECIFICATIONS FOR ALL TECHNICAL DETAILS & INFO.

ACTUAL FINISH GRADES MAY VARY DEPENDING ON LOT CONDITIONS. (REFER TO GRADING PLANS)

RAILING REQUIRED WHEN GRADE IS MORE THAN 2'-0"

COMPLIANCE PACKAGE "A1"

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2.	OCT. 1/24	REV. TILE BLOCK TO 5 STOREY BUILDING
1.	AUG. 26/24	ISSUED FOR REVIEW
NO:	DATE:	REVISION:



DRAWING TITLE: EAST (SIDE) ELEVATION



P DEL DESIGN

4370 Steeles Avenue West, Suite 203

Woodbridge, Ontario L4L 4Y4 T: 416 453 9985 e-mail: peterd@pdeldesign.ca www.pdeldesign.ca

The undersigned has reviewed and takes responsibility for this design, and has the qualifications and meets the requirements set out in the Ontario Building Code to design the work shown on the attached documents

OUALIFICATION INFORMATION


Required unless design is exempt under Division C, Subsection 3.2.5 of The Building Code

PETER DEL GROSSO

REGISTRATION INFORMATION

Required unless design is exempt under Division C, Subsection 3.2.4 of The Building Code

PETER DEL GROSSO

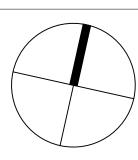



PROPOSED 5 STOREY BUILDING

15 TYLER STREET AURORA, ONTARIO

DATE: JULY 26/24 AREA: DRAWN BY: PDG SCALE:

DRAWING No.:

A-08

PROJECT No.: -00-00



REFER TO TRUSS SHOP DILGS. FOR COMPLETE TRUSS LAYOUT AND SPECIFICATIONS

REFER TO JOIST MANUFACTURER'S SPECIFICATIONS FOR ALL TECHNICAL DETAILS & INFO.

ACTUAL FINISH GRADES MAY VARY DEPENDING ON LOT CONDITIONS. (REFER TO GRADING PLANS)

RAILING REQUIRED WHEN GRADE IS MORE THAN 2'-0"

COMPLIANCE PACKAGE "A1"

The Architectural Technologist is not responsible for the accuracy of survey, structural, mechanical, electrical, etc. engineering information shown on the drawing. Refer to the appropriate engineering drawings before proceeding

Contractor shall check all dimensions on the work and report any discrepancy to the Architectural Technologist before proceeding. Construction must conform to all applicable Codes and Requirement of Authorities having Jurisdiction.

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This drawing is not to be scaled.

This drawing is not to be used for construction unless signed by the Architectural Technologist.

8.		
7.		
6.		
5.		
4.		
3.		
2.	OCT. 1/24	REV. TILE BLOCK TO 5 STOREY BUILDING
1.	AUG. 26/24	ISSUED FOR REVIEW
 ۱O:	DATE:	REVISION:



SOUTH (REAR) ELEVATION



P DEL DESIGN 4370 Steeles Avenue West,

Suite 203 Woodbridge, Ontario L4L 4Y4

T: 416 453 9985 e-mail: peterd@pdeldesign.ca www.pdeldesign.ca

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OUALIFICATION INFORMATION

Required unless design is exempt under


Division C, Subsection 3.2.5 of The Building Code

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REGISTRATION INFORMATION Required unless design is exempt under

Division C, Subsection 3.2.4 of The Building Code

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PROPOSED 5 STOREY BUILDING

15 TYLER STREET AURORA, ONTARIO

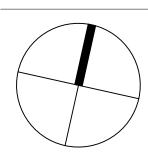AREA: **DATE:** JULY 26/24 DRAWN BY: PDG SCALE:

DRAWING No.:

A-09

PROJECT No.: -00-00